#### **PROJECT:**

PROPOSED NEW 1 UNIT STANDARD DESIGN OF FARM LABOUR QUARTERS, **BRUNEI DARUSSALAM** (FOR 5 PERSONS) - OPTION 2

#### **CLIENT:**

DEPARTMENT OF AGRICULTURE AND AGRIFOOD, **BRUNEI DARUSSALAM** 

#### **ADDRESS:**

N/A

Printed: 3/9/2022 10:12:35 AM Schematic Design Project Status Project Date 18/08/2022

No	Description	Date



Client Name and Approved by

Department of Agriculture and Agrifood, BD

Project Name And Address

PROPOSED NEW 1 UNIT STANDARD DESIGN OF FARM LABOUR QUARTERS, BRUNEI DARUSSALAM (FOR 5 PERSONS) - OPTION 2

Drawing Name

**COVER PAGE & DRAWING NOTES** 

Designed By	KHS	
Drawn By	KHS/SHA	
Checked By	AQI	
Scale	1:20	
Date	08/31/22	
Project No	Sheet No	Rev.
DD120	1	

#### **DRAWING NOTES**

- The following designs were developed up to Working Drawing (with pre-approval from ABCi for building design/TBC) and are considered as sufficient for Authority Submission.
- 2. No sites were allocated for the units at this stage. Therefore, once a site is allocated, Applicant(s) will need to appoint Qualified Person(s) to include the additional drawing information.
- 3. These changes and/or additional information will need to be included in the relevant drawings as per required by the Authority.
- These changes and/or additional information will be subjected to the approval of Client, Department of Agriculture and Agrifood, Brunei Darussalam.
- All development applications for the units will require a Qualified Person(s) to be appointed for the process of applying for:
  - Planning Approval (including Infrastructure Submission –applicable for 1 unit development)
  - **Building Approval**
  - Permit to Start Construction
  - Occupational Permit

### **ABBREVIATIONS**

 $\langle W1 \rangle$ 

**ROOM NAME** 

10 m<sup>2</sup>

RL	Roofline	AW	Aluminum Awning Wind
DP	Downpipe	LV	Aluminum Louvre Wind
FT	Floor Trap	FG	Fixed Glass
GT	Gully Trap	SHR	Shower
MH	Manhole	NTS	Not to Scale
FFL	Final Floor Level	APPROX	Approximate
CL	Ceiling Level	AVG	Average
T.B.C	To Be Confirmed	R.C	Reinforced concrete
NGL	Natural Ground Level	EXT	Existing
OHC	Overhead Cupboard	QTY	Quantity
WMS	Washing Machine Space	RM	Room
W.I.R	Walk-in-Robe	BDRM	Bedroom
SGD	Sliding Glass Door	SPEC	Specification
SW	Aluminum Sliding Window	TYP	Typical
DH	Aluminum Double Hung Window		

#### **SYMBOLS**

DOOR TAG

WINDOW TAG

GRID MARKER


**ROOM TAG** 



SECTION MARKER




**NORTH POINT & KIBLAT** 

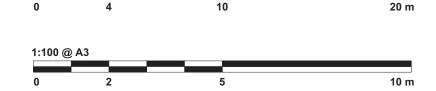

**GRAPHICAL SCALE BAR** 

	DRAWING LIST				
No.	Sheet Number	Sheet Name	Sheet Issue Date	Sheet Scale	
1	1	COVER PAGE & DRAWING NOTES	08/31/22	NTS	
2	A1	DRAWING LIST & SITE DEVELOPMENT PLAN	08/16/22	As indicated	
3	B1	GROUND FLOOR & ROOF PLAN	08/16/22	1:100	
4	C1	GROUND FLOOR CEILING PLAN	08/22/22	1:100	
5	D1	ELEVATIONS	08/16/22	1:100	
6	E1	SECTION A & B	08/16/22	1:100	
7	F1	WINDOW & DOOR SCHEDULE	08/25/22	1:50	
8	F2	IRONMONGERY SCHEDULE	09/02/22		
9	F3	VENTILATION & MATERIAL, SANITARYWARE & FITTINGS SCHEDULE	08/26/22	As indicated	
10	G1	TB & SHOE WASHING AREA DETAILS	08/26/22	As indicated	
11	G2	KITCHEN DETAILS	08/31/22	1:50	
12	G3	DOOR JAMB, TYPICAL DPC, GUTTER AND SURFACE DRAIN DETAILS	09/01/22	As indicated	
13	K1	GROUND FLOOR ELECTRICAL LAYOUT PLAN	09/02/22	1:100	
14	P1	ROOM PLANS & FURNITURE SCHEDULE	08/27/22	As indicated	

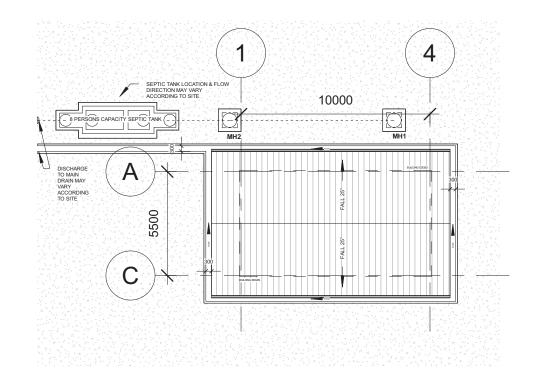

# SCALE 1:200

1:200 @	) A3					
0	4	1	1	0	:	20 m

Printed:	9/23/2022 2:35:52 PM
Paper size:	A3-LV
Project Status	Schematic Design
Project Date	18/08/2022

No	Description	Date



Contact No: 2610380

Khalid Haji Sirat BG 3122
Registeration No: 004 Mat

Client Name and Approved by:

Department of Agriculture and Agrifood, BD


Project Name And Address

PROPOSED NEW 1 UNIT STANDARD DESIGN OF FARM LABOUR QUARTERS, BRUNEI DARUSSALAM (FOR 5 PERSONS) - OPTION 2


Drawing Name

DRAWING LIST & SITE DEVELOPMENT PLAN

Designed By	KHS	
Drawn By	KHS/SHA	
Checked By	AQI	
Scale	1:200	
Date	08/16/22	
Project No	Sheet No	Rev.
PR120	A1	

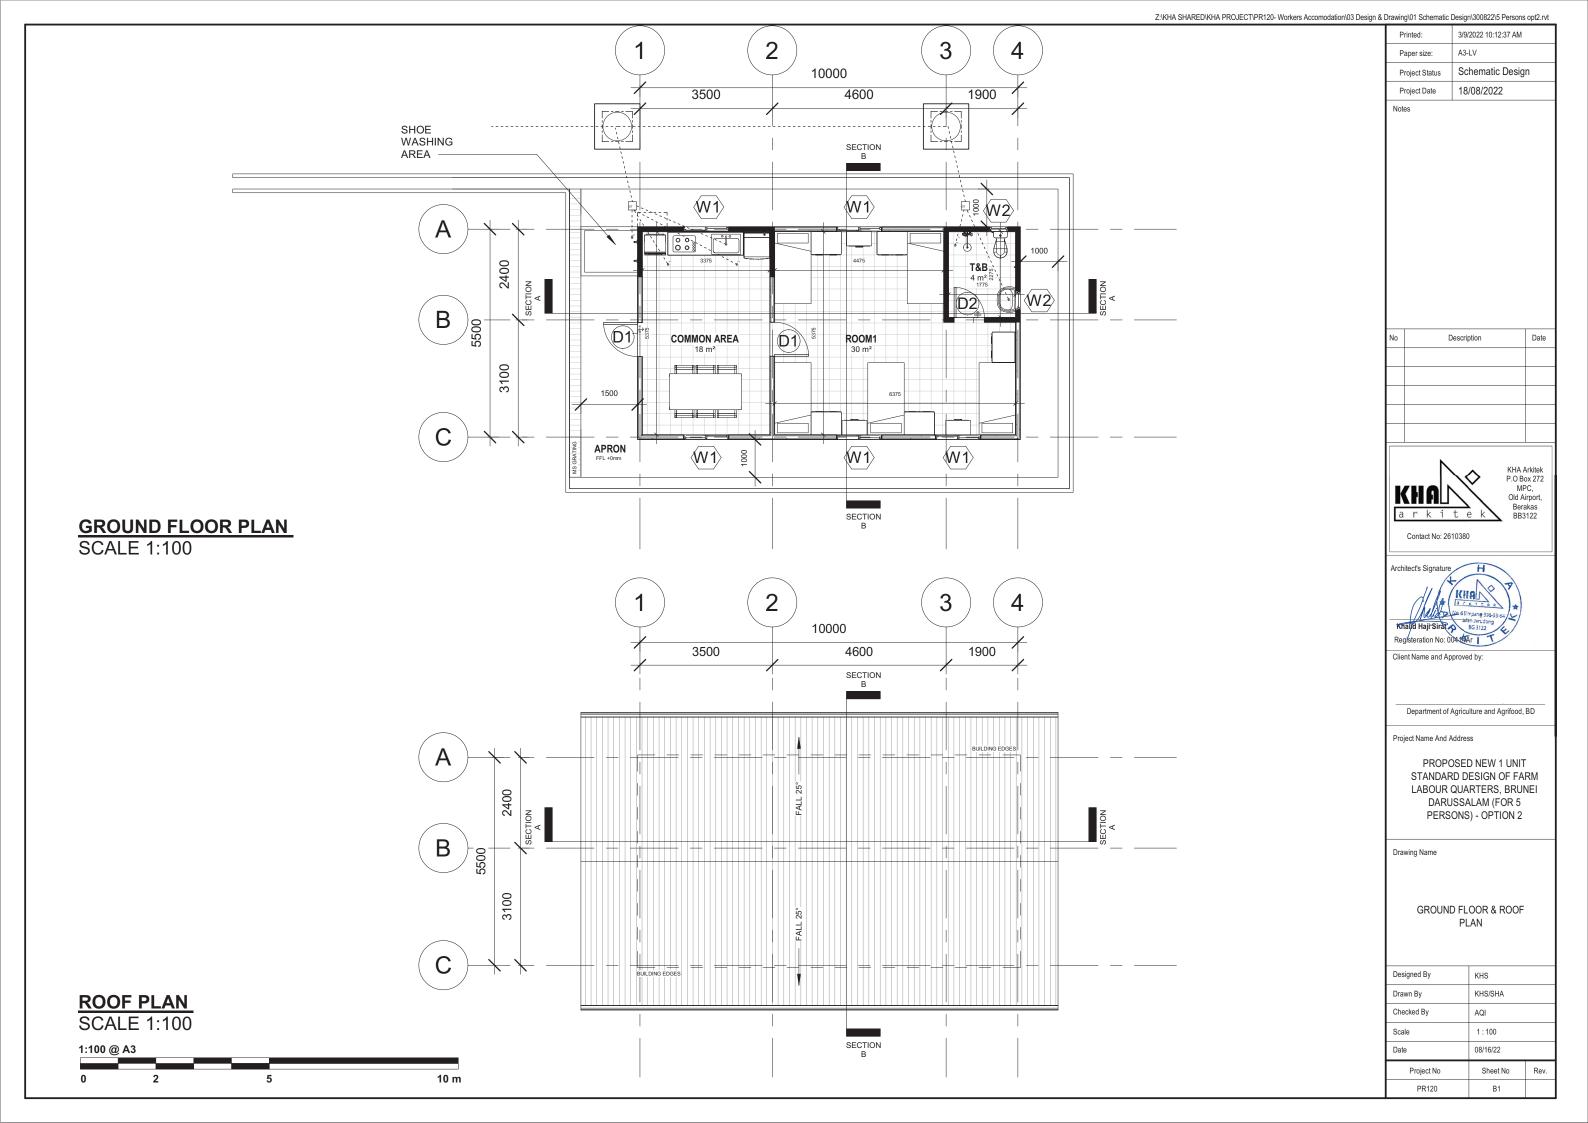



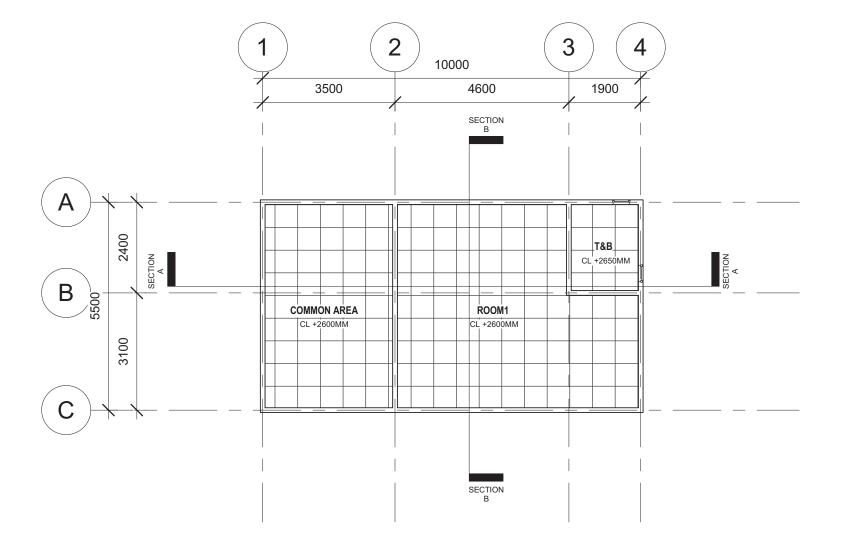

Description

Date

KHA Arkitek P.O Box 272 MPC, Old Airport, Berakas BB3122

Registeration No: 00414AT Client Name and Approved by:

Contact No: 2610380

Department of Agriculture and Agrifood, BD

Project Name And Address

PROPOSED NEW 1 UNIT STANDARD DESIGN OF FARM LABOUR QUARTERS, BRUNEI DARUSSALAM (FOR 5 PERSONS) - OPTION 2


Drawing Name

GROUND FLOOR CEILING PLAN


Designed By	KHS	
Drawn By	KHS/SHA	
Checked By	AQI	
Scale	1:100	
Date	08/22/22	
Project No	Sheet No	Rev.
PR120	C1	

## GROUND FLOOR CEILING PLAN SCALE 1:100

1:100 @ A	43		
0	2	5	10 m

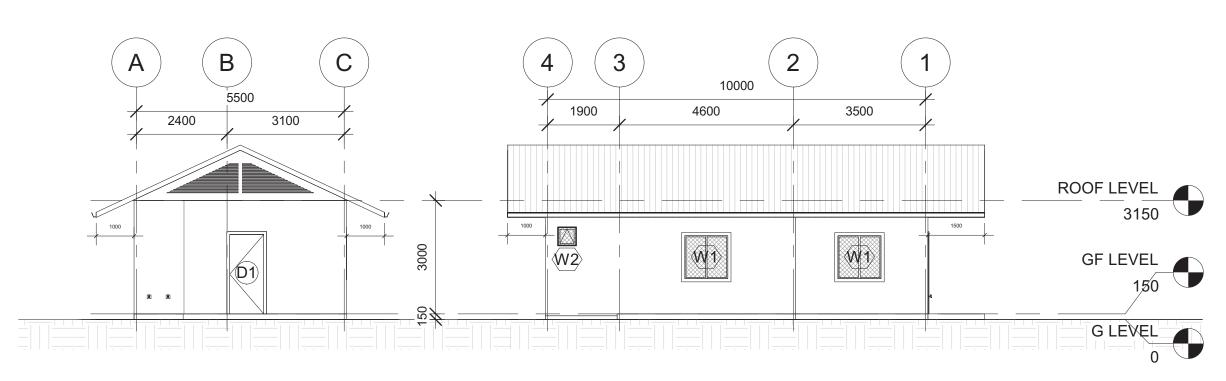

## FRONT & LEFT ELEVATION SCALE 1:100

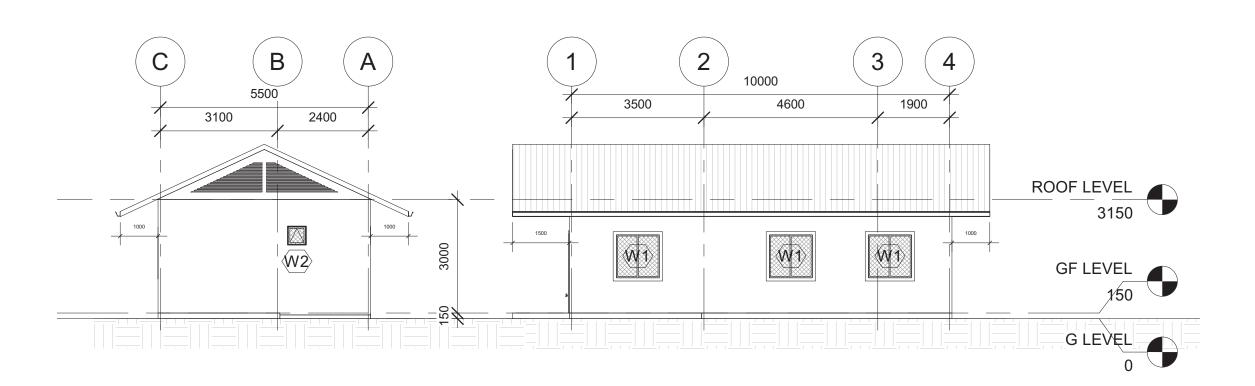

## REAR & RIGHT ELEVATION SCALE 1:100

1:100 (	@ A3		
0	2	5	10 m

Printed:	3/9/2022 10:12:38 AM
Paper size:	A3-LV
Project Status	Schematic Design
Project Date	18/08/2022

No	Description	Date



Contact No: 2610380

Client Name and Approved by:

Department of Agriculture and Agrifood, BD


Project Name And Address

PROPOSED NEW 1 UNIT STANDARD DESIGN OF FARM LABOUR QUARTERS, BRUNEI DARUSSALAM (FOR 5 PERSONS) - OPTION 2


Drawing Name

**ELEVATIONS** 

Designed By	KHS	
Drawn By	KHS/SHA	
Checked By	AQI	
Scale	1:100	
Date	08/16/22	
Project No	Sheet No	Rev.
PR120	D1	

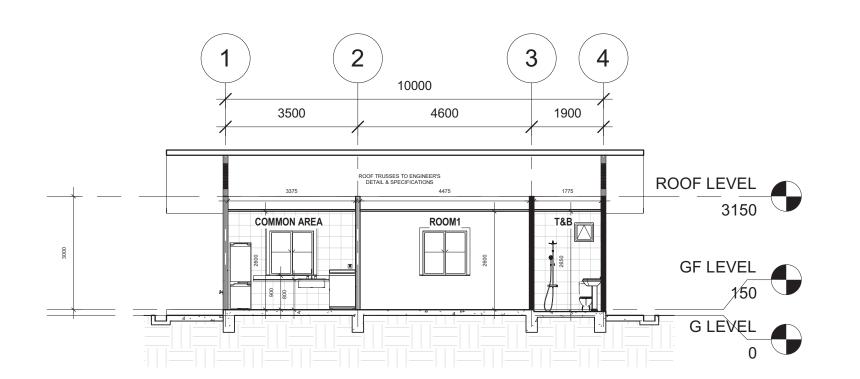

SECTION A-A SCALE 1:100

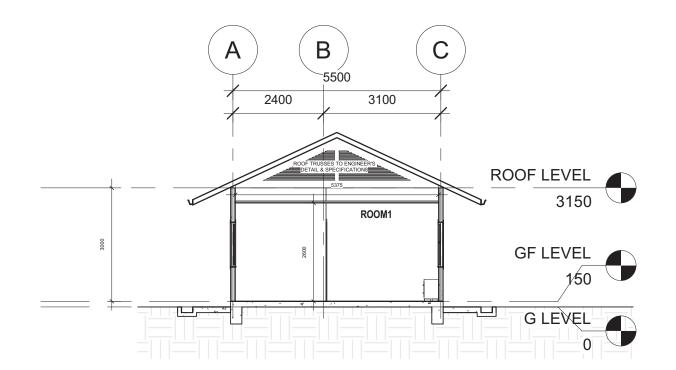

SECTION B-B SCALE 1:100

1:100 @ A3 0 2 5 10 m

Printed:	3/9/2022 10:12:39 AM
Paper size:	A3-LV
Project Status	Schematic Design
Project Date	18/08/2022

Notes

No	Description	Date



Contact No: 2610380

Architect's Signature

| No. 65:mpang 336-33-6| Main Neurolong | Main Ne

Client Name and Approved by:

Department of Agriculture and Agrifood, BD


Project Name And Address

PROPOSED NEW 1 UNIT STANDARD DESIGN OF FARM LABOUR QUARTERS, BRUNEI DARUSSALAM (FOR 5 PERSONS) - OPTION 2

Drawing Name

SECTION A & B

Designed By	KHS	
Drawn By	KHS/SHA	
Checked By	AQI	
Scale	1:100	
Date	08/16/22	
Project No	Sheet No	Rev.
PR120	E1	

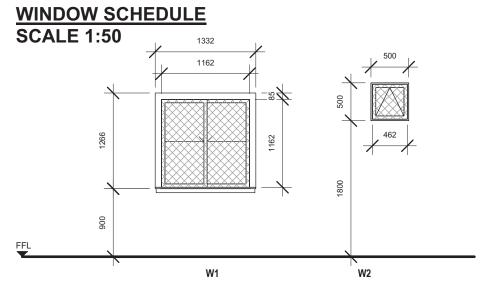

		***					
	WINDOW SCHEDULE						
CODE	Nos	Location	Level	Sill Height	Width	Height	Description
				1			
							TWO PANELS SLIDING ALLIMINILIM FRAMED WINDOW W/6MM THK CLEAR GLASS

W1	2	COMMON AREA	GF LEVEL	900	1200	1200	TWO PANELS SLIDING ALUMINIUM FRAMED WINDOW W/6MM THK. CLEAR GLASS W/ MOSQUITO NET COVER COMPLETE W/ ACCESSORIES TO MANUFACTURERS DETAILS
W1	3	ROOM1	GF LEVEL	900	1200	1200	TWO PANELS SLIDING ALUMINIUM FRAMED WINDOW W/6MM THK. CLEAR GLASS W/ MOSQUITO NET COVER COMPLETE W/ ACCESSORIES TO MANUFACTURERS DETAILS
W2	2	T&B	GF LEVEL	1800	500	500	TOP HUNG ALUMINIUM FRAMED WINDOW W/6MM THK. CLEAR GLASS W/ MOSQUITO NET COVER COMPLETE W/ ACCESSORIES TO MANUFACTURERS DETAILS

# DOOR SCHEDULE SCALE 1:50 900 900 901 750 PFFL D1 D2

	DOOR SCHEDULE					
CODE	Nos	Location	Level	Width	Height	Description
D1	1	COMMON AREA	GF LEVEL	900	2100	SINGLE LEAF SOLID FIRE RATED DOOR TO MANUFACTURER'S DETAIL
D1	1	ROOM1	GF LEVEL	900	2100	SINGLE LEAF SOLID FIRE RATED DOOR TO MANUFACTURER'S DETAIL
D2	1	T&B	GF LEVEL	800	2100	SINGLE LEAF LAMINATED SOLID DOOR TO MANUFACTURER'S DETAIL

NOTES: ANY DOOR THAT OPEN DIRECTLY TO THE OUTSIDE SHALL BE PROVIDED WITH INSECT SCREEN TO MANUFACTURERS DETAIL AND SPECIFICATION

0	0 1
Printed:	9/21/2022 4:37:11 PM
Paper size:	A3-LV
Project Status	Schematic Design
Project Date	18/08/2022

No	Description	Date



Contact No: 2610380



Client Name and Approved by:

Department of Agriculture and Agrifood, BD

Project Name And Address

PROPOSED NEW 1 UNIT STANDARD DESIGN OF FARM LABOUR QUARTERS, BRUNEI DARUSSALAM (FOR 5 PERSONS) - OPTION 2

Drawing Name

WINDOW & DOOR SCHEDULE

Designed By	KHS	
Drawn By	KHS/SHA	
Checked By	AQI	
Scale	1:50	
Date	08/25/22	
Project No	Sheet No	Rev.
PR120	F1	

#### **IRONMONGERIES SCHEDULE**

							HARDWAR	E SET		
					DORMA Stainless Steel Butt Hinge 2BB Stainless Steel, (4"x 3.0" x 2.5mm) or equivalent	DORMA Knob Type Lockset CK800 Series 60mm Grade 2 – US32D Finish CK 801 Entrance Function or equivalent	DORMA Knob Type Lockset CK800 Series 60mm Grade 2 – US32D Finish CK 803 Privacy Function or equivalent	ELITE 500 Door Stopper S066701 or equivalent	DORMA Barrel Bolt 2750x300MM SNP or equivalent	UNITY DGS01 stainless steel security door guard
	DOOR	WIDTH x HEIGHT	QTY	DOOR TYPE	H1	L1	L2	A1	A2	A3
	SCHEDULE	(mm)		BOOKTIFE	HINGES	LOCKS	SETS	ACCE	SSORIES	
GROUND FLOOR										
COMMON AREA	D1	900 x 2100mm	1	FIRE DOOR SINGLE	3	•		•		•
ROOM 1	D1	900 x 2100mm	1	FIRE DOOR SINGLE	3	•	•	•		
ТВ	D2	800 x 2100mm	1	LAMINATED SOLID DOOR SINGLE	3		•		•	

	I	
CODE	CATEGORIES	IMAGES
H1	HINGES	
L1	LOCKSE	
L2		
NO.1		
NO.2	ACCESSORIE S	200
NO.3		

NOTES: BRAND MAY VARIES TO SUIT USER'S SAFETY AND THE ARCHITECT'S APPROVAL

Printed:	3/9/2022 10:12:40 AM
Paper size:	A3-LV
Project Status	Schematic Design
Project Date	18/08/2022

Notes

No	Description	Date



Contact No: 2610380

Client Name and Approved by:

Department of Agriculture and Agrifood, BD

Project Name And Address

PROPOSED NEW 1 UNIT STANDARD DESIGN OF FARM LABOUR QUARTERS, BRUNEI DARUSSALAM (FOR 5 PERSONS) - OPTION 2

Drawing Name

IRONMONGERY SCHEDULE

Designed By	KHS	
Drawn By	KHS/SHA	
Checked By	AQI	
Scale	1:50	
Date	09/02/22	
Project No	Sheet No	Rev.
PR120	F2	

#### **VENTILATION SCHEDULE**

VENTILATION CONEDO							
ROOM/SPACE	AREA	VENTILA	ATION	LIGHTING	WINDOWS &	MECHANICAL	
	(MSQ)	REQUIRED PROVIDE		PROVIDED	DOORS	MECHANICAL	
GROUND FLOOR							
COMMON ROOM	18 MSQ	1.8 MSQ	4.7 MSQ	2.4 MSQ	W1 (2), D1 (1)	SPLIT AC , CEILING FAN	
ROOM 1	30 MSQ	3.0 MSQ	4.2 MSQ	3.6 MSQ	W1 (3)	SPLIT AC , CEILING FAN	
T&B	4 MSQ	0.4 MSQ	0.4 MSQ	0.3 MSQ	W2 (2)	EXHAUST FAN	

#### **SANITARYWARE & FITTINGS SCHEDULE**

MATERIAL CODE NO.	WATER CLOSET	LAVATORY		FAUCET		SHOWER FAUCET	PAPER HOLDER	TOWEL BAR	MIRROR	ANAL SPRAY / WASHLET	SINK	FLOOR TRAP
	01	01	01	02	03	01	01	01	01	01	01	01
GROUND F	GROUND FLOOR											
EXTERIOR	-	-	-	2	-	-	-	-	-	-	-	1
COMMON AREA	-	-	-	1	1	-	-	-	-	-	1	2
T&B	1	1	1	-	-	1	1	1	1	1	-	2
TOTAL	1	1	1	3	1	1	1	1	1	1	1	5

CODE

Printed:	9/21/2022 4:37:16 PM
Paper size:	A3-LV
Project Status	Schematic Design
Project Date	18/08/2022

#### **MATERIAL SCHEDULE**

	FLOOR WALL CEILING ROOF															
		FLO	UK					ALL					CEILI	NG	ROOF	
AREA	F1	F2	F3	F4	W1	W2	W3	W4	W5	W6	W7	C1	C2	C3	R1	R2
GROUND FLOOR																
APRON				•												
COMMON ROOM	•	•					•	•				•		•	•	•
COMMON ROOM (KITCHEN)	•	•	•		•	•			•	•	•	•		•	•	•
ROOM 1	•	•					•	•				•		•	•	•
T&B	•	•	•		•	•			•	•	•		•	•	•	•

CODE	FLOOR FINISHES
F1	300mm X 300mm homogeneous non-slip tile, colour and pattern to be decided by client
F2	Grouting
F3	Waterproofing Treatment or equivalent. All application shall be in accordance to manufacturer specification.
F4	Cement Screed to level

Notes: All potentinally wet area shall be anti slip surface tiles

CODE	WALL FINISHES
W1	25mm Thick Plaster
W2	Brick Wall
W3	ICI paint to manufacturer specification or equivalent, colour and pattern to be decided by client
W4	Light Dry Wall with metal framing
W5	300mm x 300mm Ceramic tiles, colour and pattern to be decided by client
W6	Bonding agent
W7	Grouting

Notes: For External Walls, dry wall complete with metal framing; one side lined with gypsum board and one side with cement board.

CODE	CEILING FINISHES
C1	12mm Gypsum board with metal framing. ICI paint to manufacturer specification, colour and pattern to decided by client
C2	6mm Cement board with metal framing
C3	ICI paint to manufacturer specification or equivalent

CODE	ROOF FINISHES
R1	Colour Lok clip-on system profile or equivalent with 0.53/054mm thickness including joists and purlins and accessories to manufacturer and installation specification, colour and pattern to be decided by client
R2	Waterproofing, all application and installation shall be in accordance to manufacturer specification

CODE	WATER CLOSET	
01	SHOWY "WASHDOWN" 2-PIECE CLOSET (630 X 440 X 775MM) S-trap, 250mm Roughing-in. p-trap, 180mm Rouching-in or equivalent	
CODE	LAVATORY	
01	SHOWY-6851 WASHBASIN C/W FULL PEDESTAL (520 X 440 X 800MM) or equivalent	
CODE	FAUCET	
01	SHOWY-3006 "HIGHWAY" EXCLUSIVE S/L BASIN MIXER C/W SWIVEL SPOUT Stock Code: SHOWY-3006-000 or equivalent	
02	SHOWY-2908 "BUTTERFLY" BIB TAP C/W 1/2" NOZZLE Stock Code: SHOWY-1755-000 or equivalent	
03	SHOWY-3110-3000 "HIGH-GRADE" METAL SINGLE LEVER SINK TAP. Stock Code: SHOWY-3110-001 or equivalent	
CODE	SHOWER FAUCET	
01	SHOWY-3011-3001(R) "CAUSEWAY" 3-WAY LONG BATH MIXER C/W 3041 ABS ROUND SHOWER ROSE & 3039-SH HAND SHOWER Stock Code: SHOWY-3011-013 or equivalent	

01	SHOWY-7067-000 "LUXI" S/S STAINLESS STEEL PAPER HOLDER or equivalent
CODE	TOWEL BAR
01	SHOWY-7142-000 SUS304 S/STEEL DOUBLE TOWEL BAR 600 x 120 x 55mm or equivalent
CODE	MIRROR
01	SHOWY-2998-000 480MM X 350MM SILVER COATED MIRROR or equivalent
CODE	SHOWER SPRAY / WASHLET
01	SHOWY-2480-011 "JOPAN" CHROME BIDET SPRAY C/W SHOWY-2453 120CM SILVER PVC HOSE & SHOWY-6322-000 "L" QUARTER-TURN ANGLE COCK WITH BIDET SPRAY HOLDER or equivalent
CODE	SINK
01	SHOWY-2948-000 "DAGENT" S/S LAY-ON LAUNDRY SINK (600 X 500 X 250MM) or equivalent
CODE	FLOOR TRAP
01	SHOWY-2774-000 6" X 6" CHROME ALLOY ADAPTABLE FLOOR TRAP GRATING or equivalent
	CODE  01  CODE  01  CODE  01  CODE

PAPER HOLDER

CODE	CATEGORIES	IMAGES
NO.1	WATER CLOSET	
NO.1	LAVATORY	
NO.1		
NO.2	FAUCET	Z.
NO.3		
NO.1	SHOWER FAUCET	

CODE	CATEGORIES	IMAGES
NO.1	PAPER HOLDER	
NO.1	TOWEL BAR	
NO.1	MIRROR	
NO.1	SHOWER SPRAY / WASHLET	
NO.1	SINK	
NO.1	FLOOR TRAP	鸣

NOTES: BRAND MAY VARIES TO SUIT USER'S COMFORT AND THE ARCHITECT'S APPROVAL

No	Description	Date



Contact No: 2610380

Architect's Signature

| No 65: Trang 396-33 cc |
| Malid Haji Sirat |
| Registeration No: 0041 |
| Re

Client Name and Approved by:

Department of Agriculture and Agrifood, BD


Project Name And Address


PROPOSED NEW 1 UNIT STANDARD DESIGN OF FARM LABOUR QUARTERS, BRUNEI DARUSSALAM (FOR 5 PERSONS) - OPTION 2

Drawing Name

VENTILATION & MATERIAL, SANITARYWARE & FITTINGS SCHEDULE

Designed By	KHS	
Drawn By	KHS/SHA	
Checked By	AQI	
Scale	As indicated	
Date	08/26/22	
Project No	Sheet No	Rev.
PR120	F3	

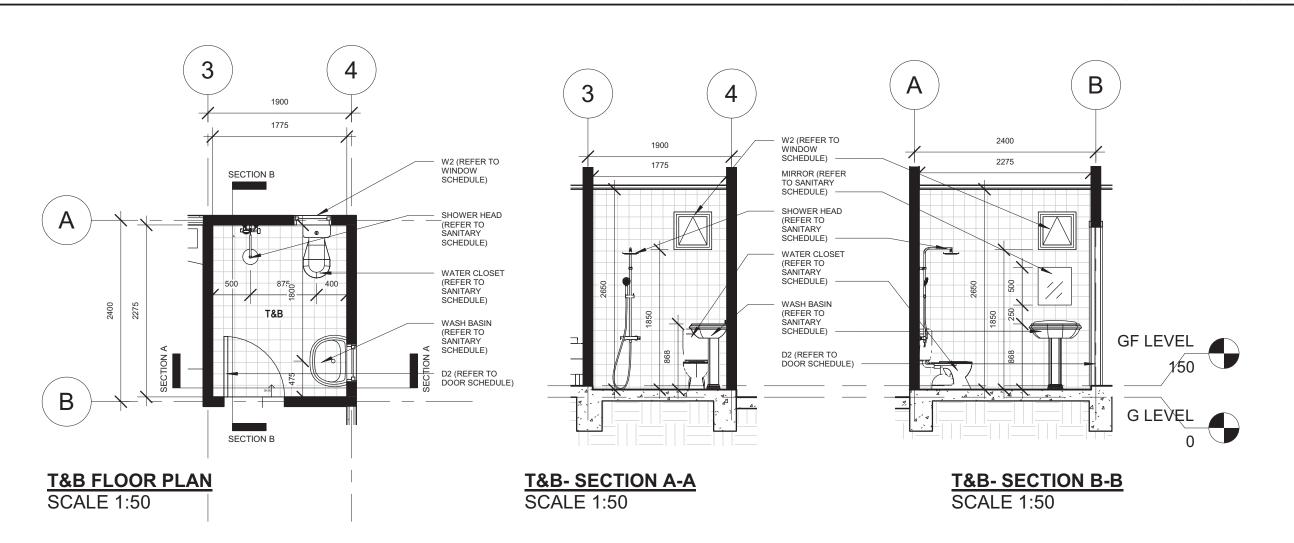

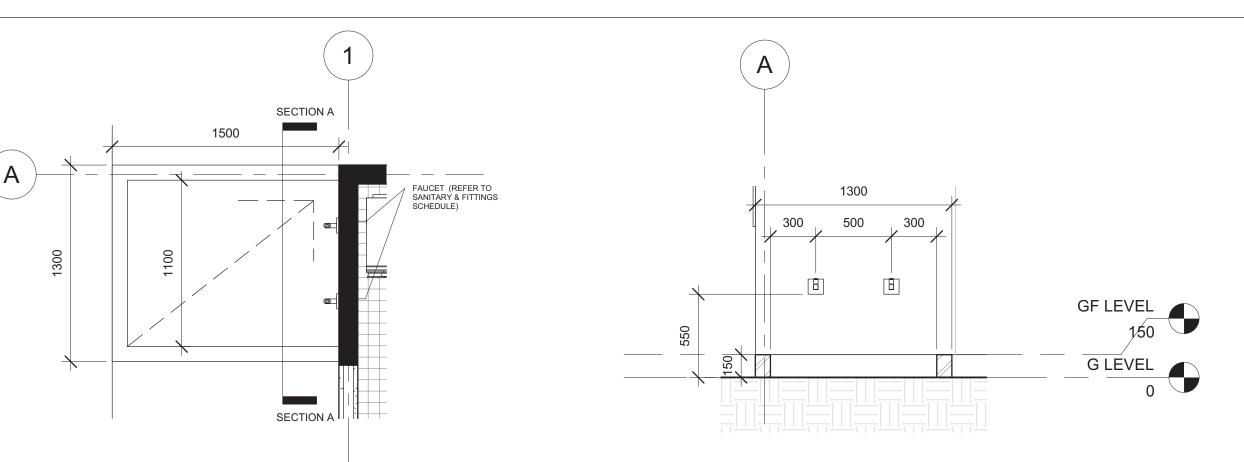

SHOE WASHING AREA SECTION A-A SCALE 1:25

SCALE 1:25

Printed:	3/9/2022 10:12:47 AM
Paper size:	A3-LV
Project Status	Schematic Design
Project Date	18/08/2022

Notes

No	Description	Date



Contact No: 2610380

Architect's Signature

| Image: Control of the cont

Client Name and Approved by:

Department of Agriculture and Agrifood, BD


Project Name And Address

PROPOSED NEW 1 UNIT STANDARD DESIGN OF FARM LABOUR QUARTERS, BRUNEI DARUSSALAM (FOR 5 PERSONS) - OPTION 2

Drawing Name

TB & SHOE WASHING AREA DETAILS

Designed By	KHS	
Drawn By	KHS/SHA	
Checked By	AQI	
Scale	As indicated	
Date	08/26/22	
Project No	Sheet No	Rev.
PR120	G1	

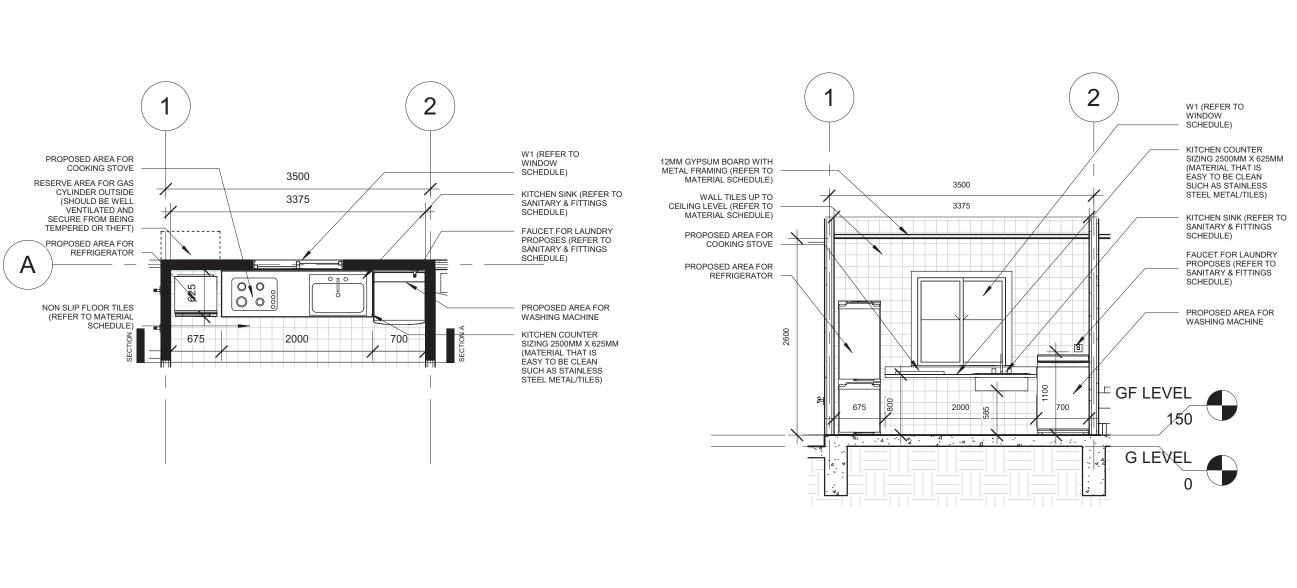

KITCHEN FLOOR PLAN SCALE 1:50

KITCHEN SECTION A-A SCALE 1:50

Printed:	3/9/2022 10:12:47 AM
Paper size:	A3-LV
Project Status	Schematic Design
Project Date	18/08/2022

Note

No	Description	Date



Contact No: 2610380

Department of Agriculture and Agrifood, BD


Project Name And Address


PROPOSED NEW 1 UNIT STANDARD DESIGN OF FARM LABOUR QUARTERS, BRUNEI DARUSSALAM (FOR 5 PERSONS) - OPTION 2

Drawing Name


KITCHEN DETAILS

Designed By	KHS				
Drawn By	KHS/SHA				
Checked By	AQI				
Scale	1:50				
Date	08/31/22				
Project No	Sheet No	Rev.			
PR120	G2				

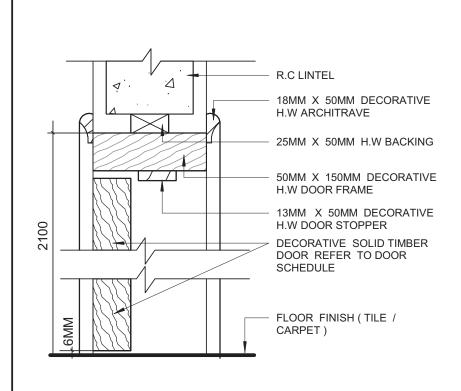

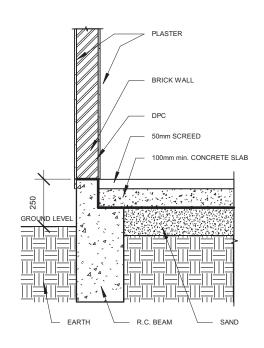

**TYPICAL DPC DETAILS (SOLID WALL)** SCALE 1:20

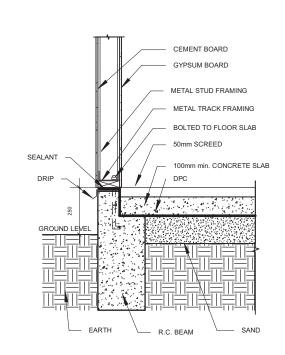

#### TYPICAL DPC DETAILS (DRY WALL)

 $\underline{\text{NOTES}}\textsc{:}$  DRY WALL CAN BE OPTED FOR WALL SANDWICH PANEL TO THE MANUFACTURER'S DETAILS AND SPECIFICATIONS

\*For External Walls, dry wall complete with metal framing; one side lined with gypsum board and one side

STEEL ROOF TRUSS

**DETAIL** 

REFER TO ENGINEER'S

**COMPATIBLE TAPE** 

DRIP EDGE

**PVC GUTTER** 

**BOLTED** 

**PVC GUTTER BRACKET** 

\*For Internal Walls, dry wall complete with metal framing; both sides lined with gypsum board.

#### Printed: 9/21/2022 4:37:21 PM Paper size: Schematic Design Project Status 18/08/2022 Project Date Notes

No	Description	Date



P.O Box 272 MPC, Old Airport, Berakas BB3122

Contact No: 2610380



Department of Agriculture and Agrifood, BD

Project Name And Address


PROPOSED NEW 1 UNIT STANDARD DESIGN OF FARM LABOUR QUARTERS, BRUNEI DARUSSALAM (FOR 5 PERSONS) - OPTION 2

Drawing Name

DOOR JAMB, TYPICAL DPC, GUTTER AND SURFACE DRAIN DETAILS

Designed By	KHS				
Drawn By	KHS/SHA				
Checked By	AQI				
Scale	As indicated				
Date	09/01/22				
Project No	Sheet No	Rev.			
PR120	G3				

#### DETAIL OF SURFACE DRAIN WITH HEAVY DUTY MS GRATING COVER

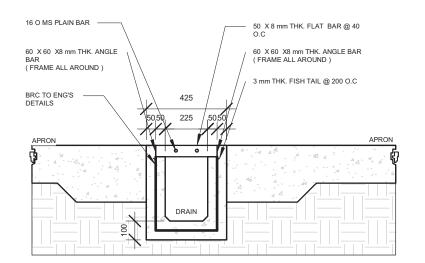


SCALE 1: 20

**DOOR JAMB** 

**DETAIL** 

SCALE 1:5

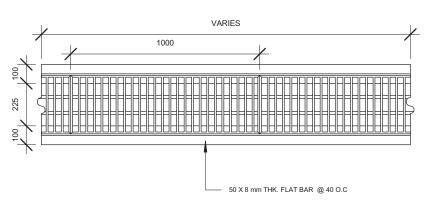


TOP DRAIN PLAN SCALE 1:20

**GUTTER DETAILS** SCALE 1:5





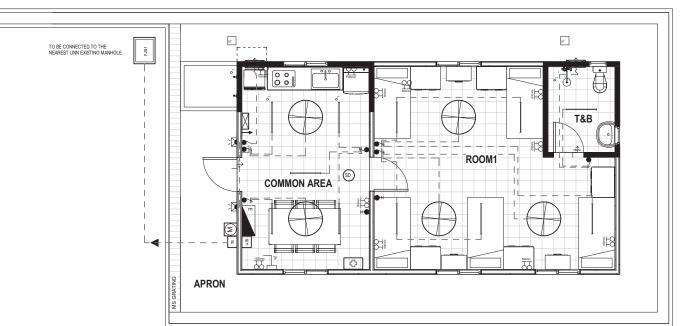

ELECTRICAL SYMBOLS							
<b>——</b>	1X LED TUBE LIGHTING						
	WALL LIGHTING (WALL MOUNTED & WEATHERPROOF LIGHT FIXTURE)						
6	ONE GANG SINGLE TOGGLED SWITCH POINT						
<b>\$</b>	ONE GANG TWO TOGGLED SWITCH POINT						
<b>*</b>	ONE GANG THREE TOGGLED SWITCH POINT						
500000	2 x 13A SOCKET OUTLET at 600mm HIGH ABOVE FINISHED FLOOR LEVEL. FOR EXTERNAL AREA, WATER PROOF BOX OR COVER SHALL BE USED						
1500mm	2 x 13A SOCKET OUTLET at 1500mm HIGH ABOVE FINISHED FLOOR LEVEL. FOR EXTERNAL AREA, WATER PROOF BOX OR COVER SHALL BE USED						
<b>#</b>	15A SWITCH SOCKET OUTLET						
	CEILING FAN						
E	ELECTRICAL DISTRIBUTION BOARD						
M	PRE-PAID ELECTRIC METER						
~\	300mm Dia. EXHAUST FAN PT.COME WITH FUSE CONNECTIOPN UNIT						

JPB SYMBOLS						
1	2.5KG (CO2) DRY EXTINGUISHER					
	FIRE BLANKET (1 x 1.2 x 1.8m)					
SD	SMOKE DETECTOR					
Т	ELECOMMUNICATION SYMBOLS					
	TELEPHONE OUTLET					
ATB	ACCESS TERMINATION BOX					
ТВ	TERMINATION BOX					
FIRST AID SYMBOLS						
(†)	FIRST AID KIT BOX					

Printed:	3/9/2022 10:12:50 AM
Paper size:	A3-LV
Project Status	Schematic Design
Project Date	18/08/2022

No	Description	Date	

KHA Arkitek P.O Box 272 MPC, Old Airport, Berakas BB3122



Contact No: 2610380



Client Name and Approved by:

Department of Agriculture and Agrifood, BD

Project Name And Address

PROPOSED NEW 1 UNIT STANDARD DESIGN OF FARM LABOUR QUARTERS, BRUNEI DARUSSALAM (FOR 5 PERSONS) - OPTION 2


Drawing Name

GROUND FLOOR ELECTRICAL LAYOUT PLAN

Designed By	KHS			
Drawn By	KHS/SHA			
Checked By	AQI			
Scale	1:100			
Date	09/02/22			
Project No	Sheet No	Rev.		
PR120	K1			

## GROUND FLOOR ELECTRICAL LAYOUT PLAN SCALE 1:100

10 m

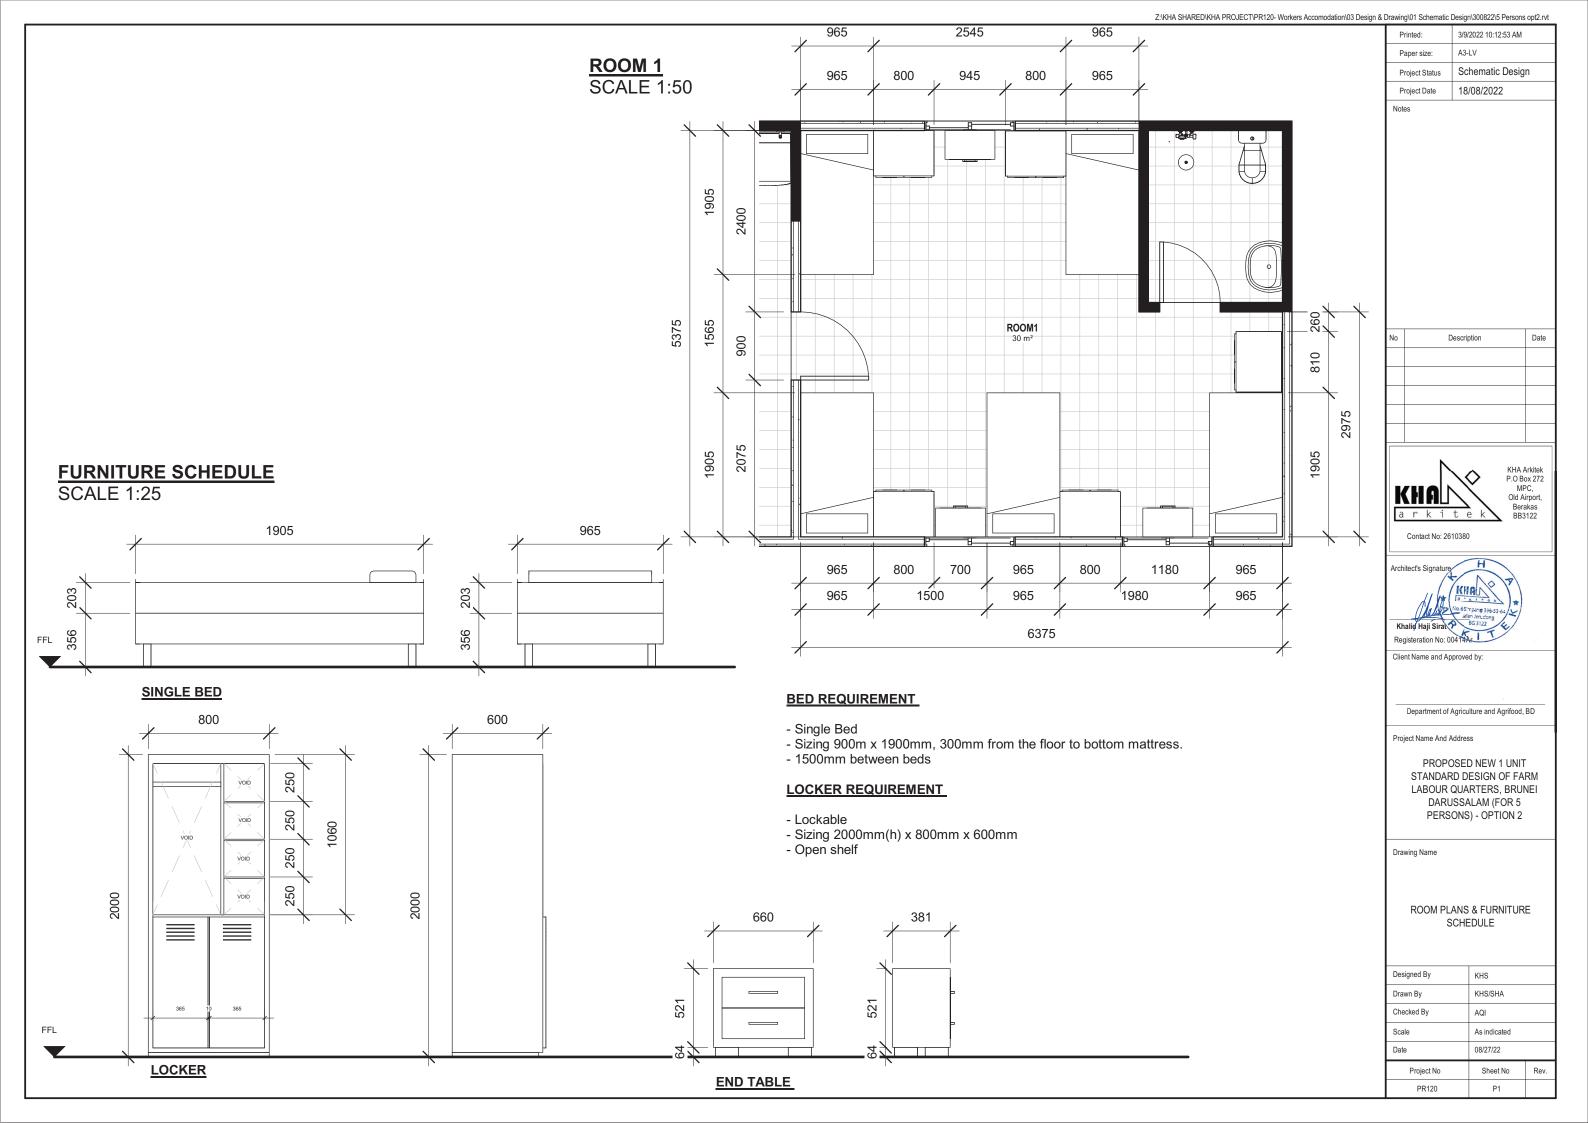

## PROPOSED NEW 1 UNIT STANDARD DESIGN OF FARM LABOUR QUARTERS, BRUNEI DARUSSALAM (FOR 5 PERSONS) -OPTION 2

	LIST OF DRAWINGS								
	DESCRIPTIONS	DRAWING NO.	REVISION	REMARKS					
$\left\{ \right. \left. \right\} $	LIST OF DRAWINGS	SBC/Q366/AFLQ/5PO2/RC/L - 100	2	}					
	GENERAL NOTES	SBC/Q366/AFLQ/5PO2/RC/G-100							
3	150x150mm R.C PRECAST PILE FOUNDATION LAYOUT PLAN	SBC/Q366/AFLQ/5PO2/RC/CS-100							
4	PAD FOOTING FOUNDATION LAYOUT PLAN [ALLOWABLE STRESS OF SOIL 100 KN/m²]	SBC/Q366/AFLQ/5PO2/RC/CS-101							
5	PAD FOOTING DETAILS - 1 [ALLOWABLE STRESS OF SOIL 100 KN/m²]	SBC/Q366/AFLQ/5PO2/RC/CS-101A							
6	PAD FOOTING DETAILS - 2 [ALLOWABLE STRESS OF SOIL 100 KN/m²]	SBC/Q366/AFLQ/5PO2/RC/CS-101B							
7	PAD FOOTING FOUNDATION LAYOUT PLAN [ALLOWABLE STRESS OF SOIL 150 KN/m²]	SBC/Q366/AFLQ/5PO2/RC/CS-102							
8	PAD FOOTING DETAILS - 1 [ALLOWABLE STRESS OF SOIL 150 KN/m²]	SBC/Q366/AFLQ/5PO2/RC/CS-102A							
9	PAD FOOTING DETAILS - 2 [ALLOWABLE STRESS OF SOIL 150 KN/m²]	SBC/Q366/AFLQ/5PO2/RC/CS-102B							
1	PAD FOOTING FOUNDATION LAYOUT PLAN [ALLOWABLE STRESS OF SOIL 200 KN/m²]	SBC/Q366/AFLQ/5PO2/RC/CS-103							
1	PAD FOOTING DETAILS - 1 [ALLOWABLE STRESS OF SOIL 200 KN/m²]	SBC/Q366/AFLQ/5PO2/RC/CS-103A							
1:	PAD FOOTING DETAILS - 2 [ALLOWABLE STRESS OF SOIL 200 KN/m²]	SBC/Q366/AFLQ/5PO2/RC/CS-103B							
1:	COLUMN SCHEDULE	SBC/Q366/AFLQ/5PO2/RC/CS-104							
1	GROUND FLOOR BEAM LAYOUT PLAN	SBC/Q366/AFLQ/5PO2/RC/CS-200							
1:	GROUND FLOOR BEAM DETAILS	SBC/Q366/AFLQ/5PO2/RC/CS-201							
1	ROOF BEAM LAYOUT PLAN	SBC/Q366/AFLQ/5PO2/RC/CS-300							
1	ROOF BEAM DETAILS	SBC/Q366/AFLQ/5PO2/RC/CS-301							
	ROOF TRUSSES LAYOUT PLAN	SBC/Q366/AFLQ/5PO2/RC/CS-400							
1	ROOF TRUSSES SECTION	SBC/Q366/AFLQ/5PO2/RC/CS-401	]	May const					
{ 2	ROOF TRUSSES AND PURLIN CONNECTIONS DETAILS (FOR ROOF TRUSS TO REINFORCE CONCRETE BEAM CONNECTION)	SBC/Q366/AFLQ/5PO2/RC/CS-402	]	Unit 14, 2nd Fir, Bit. A. P us Gadong Central, Z  97 Spg-21, Gadong					
2	MISCELLANEOUS DETAILS - 1	SBC/Q366/AFLQ/5PO2/RC/MISC-100		* Spy-71- Casong *					
2	MISCELLANEOUS DETAILS - 2	SBC/Q366/AFLQ/5PO2/RC/MISC-101							

1 >	SERI BUMI CONSULTANT	CLIENT:					DESIGNED BY	THAN ZAW TUN		SCALE:	TITLE:	JOB NO:	
(Sbc)	CIVIL & STRUCTURAL ENGINEERING CONSULTANT  No: 14, 2nd FLOOR, BLOCK A, GADONG CENTRAL, SIMPANG						DRAWN BY	SAI	10	1	LIST OF DRAWINGS (OPTION 2)	SHEET NO:	
	21, JALAN GADONG, BSB, BRUNEI DARUSSALAM TEL: 673-2427275 FAX: 673-2427279 E-MAIL: sbc.brunei@gmail.com						CHECKED BY	MD. YUNUS		N.T.S	PROPOSED NEW AURIT OTANDARD REGION OF FARMA ARGUE GUARTERS		REV:
			NO.	AMENDMENTS	BY	DATE	APPROVED BY		20/09/2022		BRUNEI DARUSSALAM (FOR 5 PERSONS) -OPTION 2	SBC/Q366/AFLQ/5PO2/RC/L - 100	1

#### GENERAL

- 1.1 SETTING OUT:
  - ALL DIMENSIONS MEASURED ON SITE SHALL BE CHECKED AND CONFIRMED WITH RELEVANT ARCHITECTURAL, M&E, CIVIL AND STRUCTURAL DRAWINGS.
- 1.2 ANY DISCREPANCIES BETWEEN ARCHITECTURAL, C&S AND M&E DRAWINGS SHALL BE REFERRED TO PROJECT ARCHITECT OR STRUCTURAL ENGINEER OR
- 1.3 PLEASE NOTE THAT THE ARCHITECTURAL DRAWINGS GRID LINE AND STRUCTURAL DRAWINGS GRID LINES HAVE BEEN PURPOSELY OFF-SET TO EASE CONSTRUCTION ON STRUCTURAL MEMBERS.
- 2. STANDARDS & CODE OF PRACTICE
- 2.1 BS 8110 : 1985 STRUCTURAL USE OF CONCRETE
  2.2 PBD 12 : 2008 BUILDING GUIDELINES AND REQUIREMENTS
- 2.3 BS 4449: 1978 HOT ROLLED STEEL BARS FOR THE REINFORCEMENT OF CONCRETE
- 3. CONCRETE
- 3.1 CONCRETE STRENGTH: 25 N/mm² (GRADE 25) UNLESS OTHERWISE
  - STATED LEAN CONCRETE - 15 N/mm<sup>2</sup> - 25 N/mm<sup>2</sup> COLUMN - 25 N/mm<sup>2</sup> 25 N/mm<sup>2</sup>
- 3.2 CONCRETE COVER TO ALL REINFORCEMENT INCLUDING LINKS SHALL MEET THE 2-HOUR FIRE RATING & AS STATED BELOW (UNLESS OTHERWISE STATED)
- COLUMNS: 30mm BEAMS PILE CAPS : 75mm
- 3.3 CONCRETE CURING: TO BE CARRIED OUT BY SPRAYING WITH WATER AND COVERING WITH EITHER GUNI SACKS OR PLASTIC
- 3.4 ANY COLD JOINTS AND HACKED CONCRETE SURFACE SHALL BE APPLIED WITH APPROVED BONDING AGENT BEFORE POURING NEW
- 3.5 50mm (MINIMUM) THICK BLINDING LEAN CONCRETE SHALL BE PROVIDED BENEATH FOOTINGS, GROUND BEAMS AND ALL GROUND FLOOR SLABS
- 4. STEEL REINFORCEMENT
- 4.1 THE MINIMUM YIELD STRENGTH OF STEEL REINFORCEMENT (WITH DENOTATION "T")FOR HIGH TENSILE DEFORMED BAR(TYPE 2 - 460 N/mm², STEEL FABRIC - 485 N/mm² (UNLESS OTHERWISE STATED.
- 4.2 THE MINIMUM YIELD STRENGTH OF STEEL REINFORCEMENT
- 5. ALL WATER RETAINING STRUCTURE OR WET AREAS SHALL BE
- 6. IF REQUIRED R.C LINTEL BEAM OF SIZES 150 X 200 REINFORCED WITH 2T12 (T&B) & R6 -150 LINKS SHALL BE PROVIDED TO ALL DOORS AND WINDOWS. STIFFENER, COLUMN SIZES 150X150 TO 200X200 REINFORCED WITH 4T12 & T10-150 LINKS SHALL BE PROVIDED IF REQUIRED. (FOR EG. ON WALL OF MORE THAN 3.5m IN HORIZONTAL LENGTH OR
- 7. INCORPORATING OF M & E REQUIREMENTS IN STRUCTURAL DRAWINGS: THE CONTRACTOR TO PREPARE DETAILED SHOP DRAWINGS INCORPORATING ALL M & E. REQUIREMENTS, OPENINGS ETC INTO THE STRUCTURAL DRAWINGS AND OBTAIN THE PROJECT STRUCTURAL ENGINEER APPROVAL BEFORE PROCEEDING WITH ANY FORM OF PERMANENT CONSTRUCTION WORKS. THE CONTRACTOR SHALL RESOLVE ALL DISCREPANCIES WITH ENGINEERS REGARDING M & E WORKS PRIOR TO CONCRETING.

#### 8. NOTES FOR COMPACTION WORKS OF SUB-BASE AND SUB-GRADE.

- ALL SUB-GRADE AND SUB-BASE LAYING WORKS SHALL BE WELL COMPACTED TO OVER 95% CBR.
- MINIMUM OF FOUR NUMBER OF DRY FIELD DENSITY TESTS AND CBR TESTS SHALL BE CONDUCTED ON COMPACTED SUBGRADES AND SUB-BASE BEFORE CARRYING OUT ANY PERMANENT WORKS SUCH AS CONCRETING OF ACCESS ROAD, GARAGE NON-SUSPENDED FLOOR SLABS & HARD STANDINGS, ETC. THE TESTS RESULTS SHALL BE SUBMITTED TO CIVIL AND STRUCTURAL CONSULTANT ENGINEER FOR REVIEW AND APPROVAL TO PROCEED WITH PERMANENT WORKS (IF APPLICABLE BASIS ONLY).

#### 9.REMOVAL OF FORMWORK

A) THE TIME FOR THE REMOVAL OF FORMWORKS IS TO BE SUBJECTED TO ENGINEER'S APPROVAL,
BUT THE FOLLOWING MAY BE TAKEN AS A GUIDE TO MINIMUM TIMES APPLICABLE UNDER NORMAL CIRCUMSTANCES:

BUT THE FOLLOWING MAY BE TAKEN AS A GUIDE TO MINIMUM TIM						
	SIDE OF COLUMNS/PIERS,WALLS AND BEAMS	3 DAYS				
	SOFFIT OF SLABS (PROPS LEFT UNDER)	14 DAYS				
	PROPS OF SLABS	28 DAYS				
	SOFFIT OF BEAMS ( PROPS LEFT UNDER)	14 DAYS				
	PROPS TO SOFFIT OF BEAMS	28 DAYS				

- B) SHUTTERING AND CENTERING SHALL BE REMOVED BY GRADUAL EASING WITHOUT JARRING, AND ONLY IN THE PRESENCE OF A COMPETENT SUPERVISER, BEFORE REMOVAL OF THE SHUTTERING, THE CONCRETE SHALL BE EXAMINED, AND REMOVAL SHALL PROCEED ONLY IF THE CONCRETE HAS ATTAINED SUFFICIENT STRENGTH TO SUPPORT ITS OWN WEIGHT AND ANYCONSTRUCTIONAL OR OTHER LOADS LIKELY TO COME UPON IT. IF ANY LOADING IN EXCESS OF THE DESIGN LOAD IS ANTICIPATED, APPROVED PROPS SHALL BE PROVIDED AFTER REMOVAL OF SHUTTERING
- C) TO ENSURE THAT THE CONSTRUCTIONAL LOADS OF A FLOOR ARE SHARED BY AT LEAST TWO FLOORS BELOW IT, THE PROPS TO THE BEAMS AND SLABS OF A FLOOR SHALL NOT BE REMOVED UNTIL THE FLOOR ABOVE THE FLOOR IN QUESTION, IS STRONG ENOUGH TO SUPPORT ITSELF.

#### 10. GENERAL NOTES FOR PILING WORKS

- ALL PILES TO BE USED FOR THIS PROJECT SHALL BE OF BRUNEI DARUSSALAM MINISTRY OF DEVELOPMENT'S APPROVED TYPES AND BRAND NAMES OR AS PER S.O.'S APPROVAL.
- THE CONTRACTOR SHALL SUBMIT TO THE ENGINEER FOR APPROVAL, BEFORE ANY PILING WORK IS STARTED, DETAILS OF :-
- PILE DRIVER INCLUDING SIZE OF HAMMER AND DROP
- CONTRACTOR'S CALCULATIONS OF SETS, CALCULATED USING THE HILEY FORMULA.
- PROPOSED PROGRAM AND SEQUENCE OF PILE DRIVING INCLUDING
- NO PILING SHALL COMMENCE UNTIL THE SET VALUES SUBMITTED BY THE CONTRACTOR
- ARE APPROVED IN WRITING BY THE ENGINEER.
  THE CALCULATED SETS SHALL ONLY BE USED AS A GUIDE FOR DRIVING AND THE SET SHALL BE CONFIRMED BY THE IN-SITU PILE TEST.
- HOWEVER, PILE HYDRAULIC JACKING TO TWICE THE SAFE WORKING LOAD (MINIMUM) SHALL BE USED IF PILE HAMMERING ACTIVITIES CAUSES DISTURBANCES AND DISTRESS (EXCESSIVE VIBRATIONS) TO SURROUNDING BUILDINGS

#### 11. GENERAL NOTES FOR R.C PILES

#### R.C PILES

- ALL REINFORCED CONCRETE (R.C.) PRECAST PILES SHALL BE 150MM X 150MM REINFORCED CONCRETE PRECAST PILES OR AS PER SPECIFIED IN THE DRAWINGS
- CONCRETE GRADE SHALL BE GRADE 45 MINIMUM FOR NORMAL R.C. PRECAST PILES. THE ALLOWABLE SAFE BEARING CAPACITY OF EACH R.C. PRECAST PILES POIN
- SHALL BE 25 TONNES.
- THE EXPECTED PENETRATION DEPTH OF EACH PILE POINT IS 6 TO 15 METRES. THIS IS TO BE CONFIRMED DURING PILE DRIVING WORKS. (UNTIL PILE SET IS ACHIEVED UNLESS OTHERWISE STATED)
- THE PILE SET SHOULD BE ACHIEVED WITH THE LAST 10 BLOWS FOR LESS THAN 20mm PENETRATION (PILE HAMMER OF ABOUT ONE TONNE WITH HAMMER DROP OF ABOUT 600mm TO ONE METRE)
- ALL WELDING WORKS FOR JOINING OF PILES SHALL BE CARRIED OUT BY QUALIFIED LICENSED WELDERS
- IF ANY OF THE PILE POINTS DOES NOT PENETRATE 6 METRES DEEP INTO THE GROUND (IF PILE SET IS ACHIEVED AT LESS THAN 6 METRES PENETRATION LENGTH). THE CLIENT OR CONTRACTOR SHALL REPORT TO THE C&S CONSULTANT FOR REDESIGN REQUIREMENT OF THE PILE FOUNDATION.

#### 11a. MILD STEEL TUBULAR PILING

- 11a.1 ALL PILES SHALL BE GRADE 43 SEAMLESS MS TUBES 114.3mm  $\varnothing$  x 6.3mm THICK TO B.S. 4848 PART II WITH AN ULTIMATE LOAD CAPACITY OF NOT LESS THAN 240kN.
- 11a.2 ALL PILING WORK SHALL BE CARRIED OUT IN ACCORDANCE TO THE GENERAL SPECIFICATION AS SHOWN IN SPECIFICATION OF MATERIALS AND WORKMANSHIP

#### 12. NOTES FOR PAD FOOTING

- ALL PAD FOOTING CONSTRUCTION SHALL BE REFERRED TO THE PAD FOOTING LAYOUT PLAN N AND DETAILS
- THE DESIGN IS BASED UPON THE GROUND BEARING CAPACITY AT ABOUT 2.0
- METRES BELOW EXISTING GROUND LEVEL TO BE 150KN/m 3. CONCRETE GRADE 30 SHALL BE USED FOR ALL PAD FOOTING WORKS

#### 13. NOTES FOR BAKAU PILING

- 1. WITH A 1/2 TONNE HAMMER AND DROP OF 900mm. THE FINAL SET SHOULD NOT BE MORE THAN 75/10 BLOWS OR THE SET TO BE FINALISED BY THE ENGINEER DURING THE TEST PILING.
- ALL BAKAU PILES SHOULD BE NOT LESS THAN 75mm Ø (ON AVERAGE), ALL PILES CUT-OFF SHALL BE AT THE LOWEST WATER LEVEL. EXACT LEVEL TO BE DETERMINED ON SITE BY THE ENGINEER
- 3. IF PILE REQUIRED TO BE SPLICED TOGETHER, A TUBULAR SPLICE WITH A HEAVY PIPE 90mm Ø x 600mm LONG x 6mm THICK SHOULD BE USED AT LEAST 4 HOLES SHALL BE PROVIDED IN THE PIPE FOR DRIVING 65mm LONG NAILS SPIKE
- 4. ACTUAL SPACING OF BAKAU PILES TO BE DECIDED ON SITE

#### 14. NOTES FOR SAFETY OF EXISTING UNDER GROUND SERVICES

1. MAIN CONTRACTOR TO CARRY OUT PILOT TRENCHING (ADEQUATE GROUND INVESTIGATION) BEFORE CARRYING OUT ANY EXCAVATION WORKS FOR DRAINAGE WORKS, PILING WOKS AND OTHER WORKS THAT MAY AFFECT THE BURIED (UNDER GROUND) EXISTING SERVICES/UTILITIES SUCH AS ELECTRICAL CABLES, FIBRE OPTIC CABLES, TELECOM CABLES, WATER PIPES. .THIS IS IMPORTANT TO PREVENT ANY DAMAGE TO SUCH SERVICES /UTILITIES SAFETY THREAT TO ALL STATEHOLDERS.

#### 15. NOTES FOR WATERPROOFING WORKS:

- ALL INTERNAL OR EXTERNAL SURFACES OF WATER RETAINING STRUCTURE OR WET AREAS SUCH AS TOILETS, RC ROOF SLABS, RC GUTTERS, M&E ROOMS AND KITCHENS SHALL BE WATERPROOFED WITH APPROVED WATERPROOFING SYSTEM.
  ALL WATERPROOFING WORKS SHALL BE CARRIED OUT BY MANUFACTURER'S APPROVED
- INSTALLER/APPLICATOR AND SHALL BE APPLIED. IN STRICT ACCORDANCE TO THE MANUFACTURER'S APPROVED PROCEDURES OR AS PER ENGINEER'S APPROVAL.
- SUFFICIENT CURING TIME SHALL BE ALLOWED BEFORE INSTALLATION OF ANY PROTECTIVE SCREED OR ARCHITECTURAL FINISHES.
- WATERPROOFING SYSTEMS THAT HAS BEEN APPROVED FOR INSTALLATION SHALL CARRY A 10 YEAR WARRANTY PERIOD BY THE MANUFACTURER OR BY THE MANUFACTURER'S REPRESENTATIVES OR BY THE APPROVED LOCAL DISTRIBUTOR/APPLICATOR.

#### 16. GENERAL NOTES FOR ANY STRUCTURAL STEEL WORKS

- MAIN CONTRACTOR SHALL SUBMIT SHOP DRAWINGS FOR ALL STEEL WORKS FOR STRUCTURAL ENGINEER'S APPROVAL BEFORE ORDERING, PURCHASING, FABRICATING AND ERECTING ANY STEEL STRUCTURAL WORKS
- PROPOSED CONNECTION DETAILS TO BE PROVIDED IN THE STRUCTURAL SHOP DRAWINGS FOR STRUCTURAL ENGINEER'S APPROVAL.
- ALL STEEL SECTION MEMBERS SHALL BE SAND BLASTED BEFORE APPLYING ANY APPROVED ANTI-CORROSION COATING SYSTEM.
- 4. ALL WELDING WORKS SHALL BE CARRIED OUT BY QUALIFIED LICENSED WELDERS.

#### 17. NOTES FOR TURFING

- ALL TURFS SHALL BE 225MM SQUARE FROM AN APPROVED SOURCE FREE FROM LALLANG AND
- BLACK EARTH OF 50MM THICKNESS SHALL BE SPREAD ON TO THE GROUND WHERE TURFING IS
- SPOT TURFING SHALL BE LAID AT 300MM CENTRES.
- CLOSED TURFING TO BANKS SHALL BE PEGGED IN PLACE WITH 25MM DIAMETER PEGS 225MM LONG. ALL TURFING SHALL BE WATERED UNTIL SATISFACTORILY ESTABLISHED AND ALL TURFING THAT HAS BECOME DEFECTIVE WITHIN SIX MONTHS SHALL BE REPLACED AT THE CONTRACTOR'S EXPENSE
- DURING THE PERIOD OF THE WORKS AND MAINTENANCE, THE CONTRACTOR SHALL KEEP ALL TURFED AREAS WATERED, MOWN OR CUT AND CLEARED OF GRASS CUTTING TO THE SATISFACTION OF THE ENGINEER. THE FIRST CUT SHALL BE MADE WHEN THE GRASS IS 100MM HIGH, FOLLOWED BY REGULAR CUTTING SO THAT THE VEGETATION AT NO TIME EXCEEDS 150MM IN HEIGHT.

#### 18. DRAWING NOTE:

ALL STRUCTURAL DRAWING ARE DRAWN TO APPROXIMATE SCALE. ANY DISCREPANCY IN STRUCTURAL DRAWING DIMENSIONS, EXACT DIMENSION SHALL BE REFERRED TO STRUCTURAL ENGINEER

#### 19. GENERAL NOTES FOR FLOOR HARDENER REQUIREMENTS:

ALL CONCRETE SLAB SURFACES WHICH ARE NOT COVERED WITH HEAVY DUTY DECORATIVE TILES AND TO BE USED AS CAR PARKS OR ACCESS ROADS (FOR SELECTED AREAS) SHALL BE APPLIED WITH SUITABLE FLOOR HARDENERS SYSTEM (TO INCLUDE POWER FLOAT TROWELLING IF APPLICABLE)

#### 20. GENERAL NOTES FOR BRICKWALL WORKS:

- ALL BRICKS TO BE USED SHALL BE REGULAR IN SIZE AND APPROVED BY ABCI REINFORCED CONCRETE STIFFENERS (100x100 WITH APPROPRIATE REINFORCEMENTS)SHALL BE PROVIDED AT EVERY INTERVAL OF 3.5m OF BRICK WORK LENGTH

## 21. NOTES FOR WORKPLACE SAFETY, HEALTH AND ENVIRONMENT COMPLIANCE & INSURANCES & TEMPORARY WORKS:

- MAIN CONTRACTOR SHALL ENSURE TO COMPLY FULLY WITH ALL PREVAILING RULES, REGULATIONS AND LAWS OF NEGARA BRUNEI DARUSSALAM ON WORKPLACE SAFETY, HEALTH AND ENVIRONMENTAL ASPECTS THROUGHOUT THE DURATION OF THE CONSTRUCTION PERIOD AND DEFECTS LIABILITY PERIOD
  2. MAIN CONTRACTOR SHALL ENSURE THAT ALL APPLICABLE INSURANCES ARE VALID THROUGHOUT THE
- CONSTRUCTION PERIOD AND DEFECTS LIABILITY PERIOD SUCH AS CONTRACTOR'S ALL RISK INSURANCE OR OTHERS SUCH AS WORKMEN COMPENSATION INSURANCE POLICY, PUBLIC LIABILITY INSURANCE POLICY AND FIRE INSURANCE POLICY(WHICHEVER IS APPLICABLE AS PER SUPERINTENDING OFFICERS
- 3. MAIN CONTRACTOR SHALL EMPLOY INDEPENDENT CONSULTANT TO CARRYOUT DESIGN WORKS FOR ALL TEMPORARY WORKS AND THAT SUCH TEMPORARY WORKS DESIGN REQUIREMENT ARE FULLY COMPLIED

#### 22. NOTES FOR ROOF TRUSSES:

- ROOF TRUSSES SHALL BE LIGHTWEIGHT PROPRIETARY SYSTEM SUCH AS LYSAGTH SMART TRUSS SYSTEM OR APPROVED TECHNICAL EQUIVALENT SHALL BE DESIGNED BY MANUFACTURER COMPAN
- THE INSTALLATION WORKS SHALL BE CARRIED OUT BY MANUFACTURER'S APPROVED INSTALLER






SERI BUMI CONSULTANT


				DESIGNED BY	THAN ZAW TU
				DRAWN BY	SAI
					O711
				CHECKED BY	MD. YUNUS
NO.	AMENDMENTS	BY	DATE	APPROVED BY	ı




N.T.S


GENERAL NOTES (OPTION 2) POJECT PROPOSED NEW 1 UNIT STANDARD DESIGN OF FARM LABOUR QUARTERS, BRUNEI DARUSSALAM (FOR 5 PERSONS) -OPTION 2 BC/Q366/AFLQ/5PO2/RC/G -10

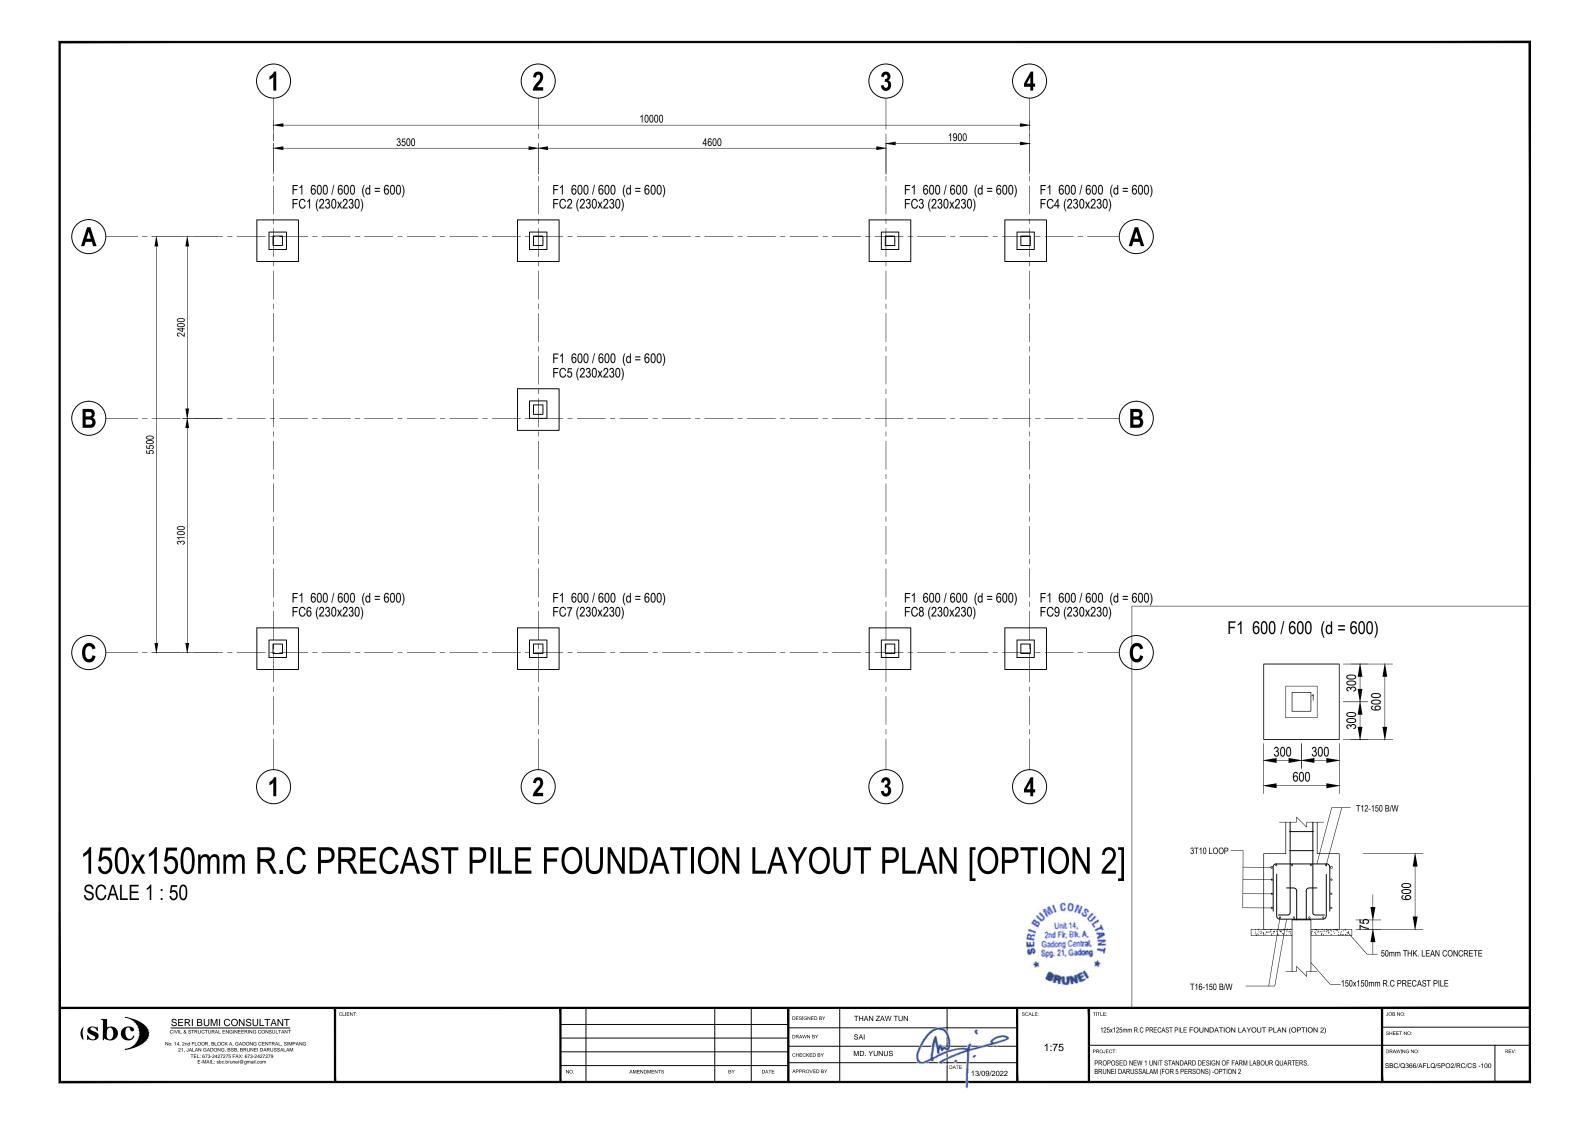


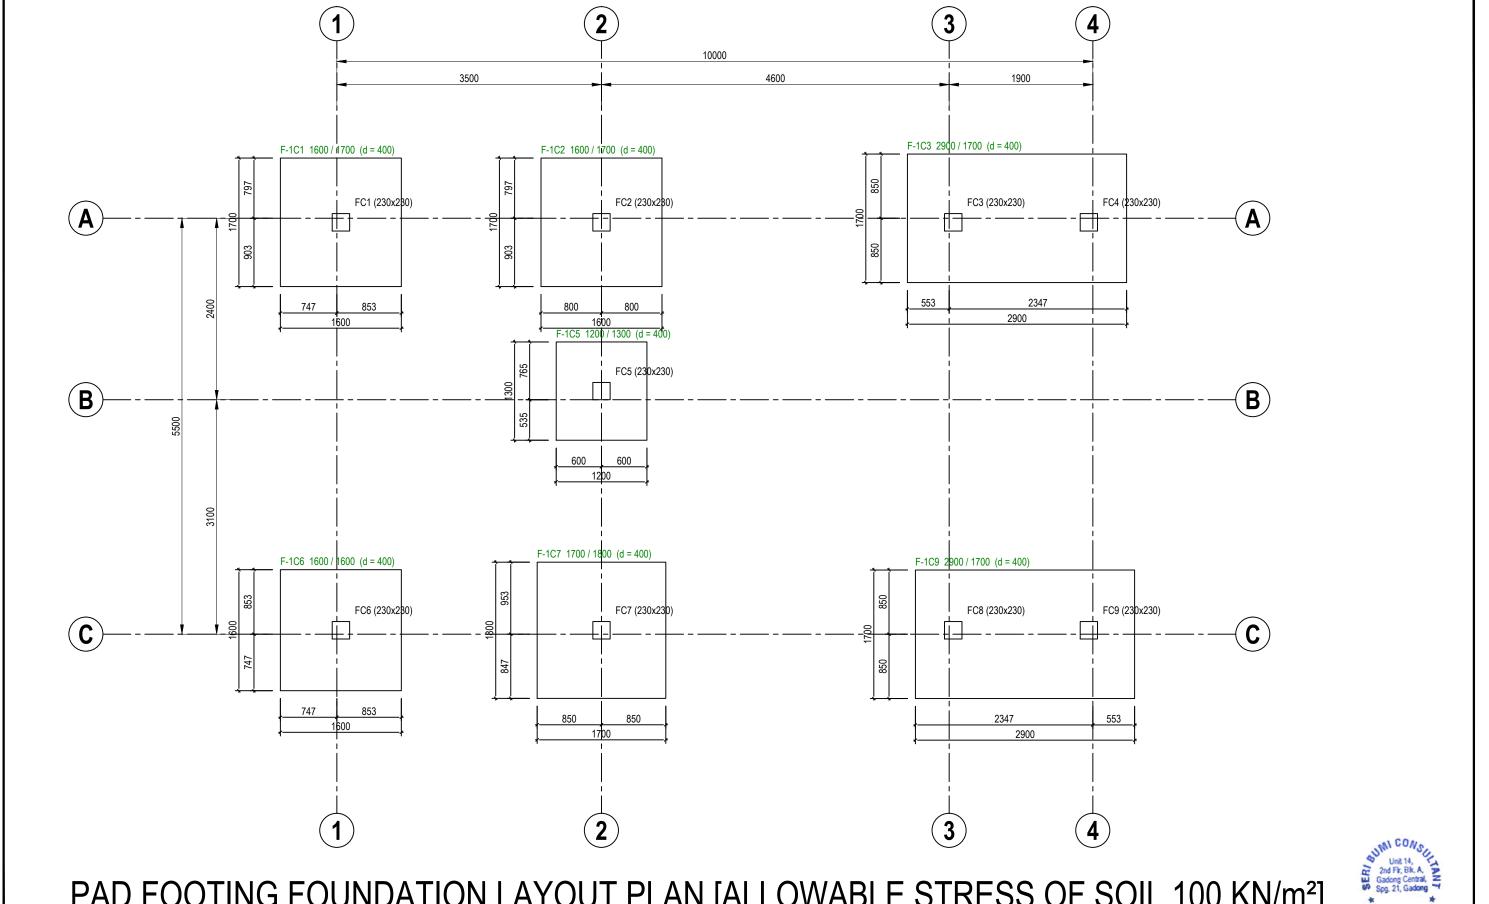

# PAD FOOTING FOUNDATION LAYOUT PLAN [ALLOWABLE STRESS OF SOIL 100 KN/m²] SCALE 1:75

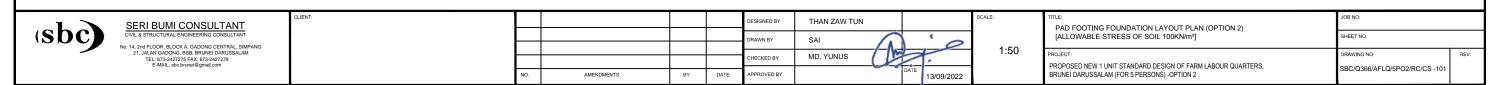


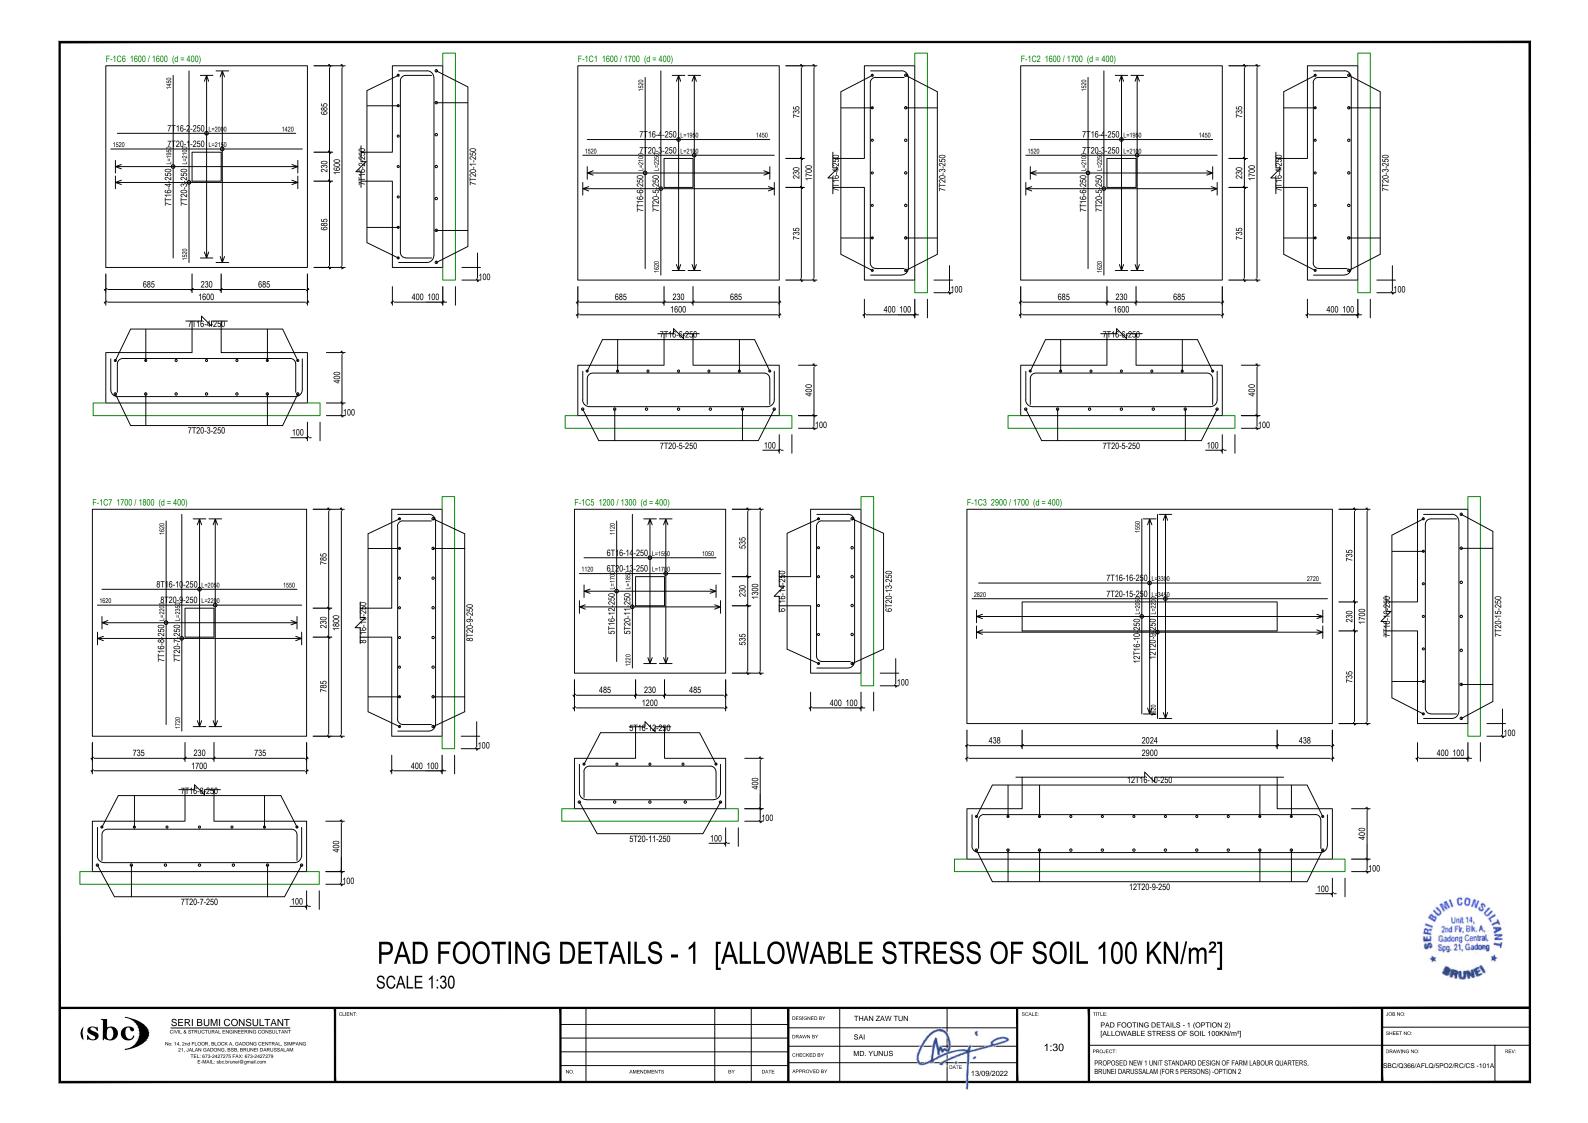


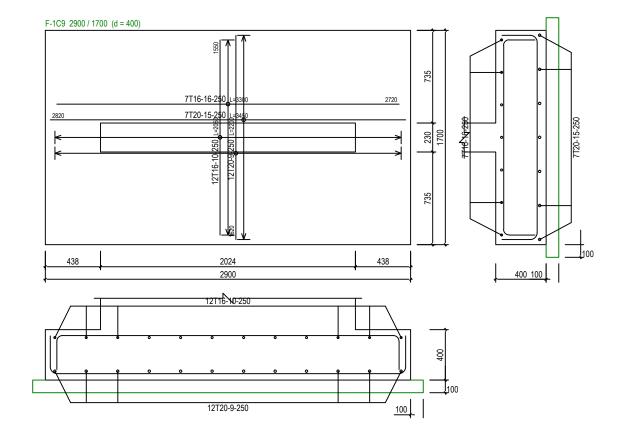

# PAD FOOTING DETAILS - 2 [ALLOWABLE STRESS OF SOIL 100 KN/m²] SCALE 1:30



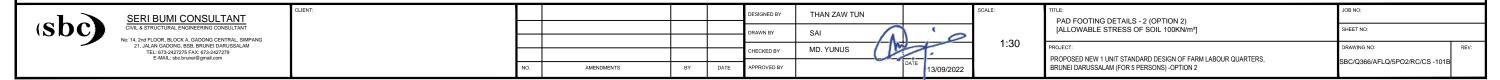

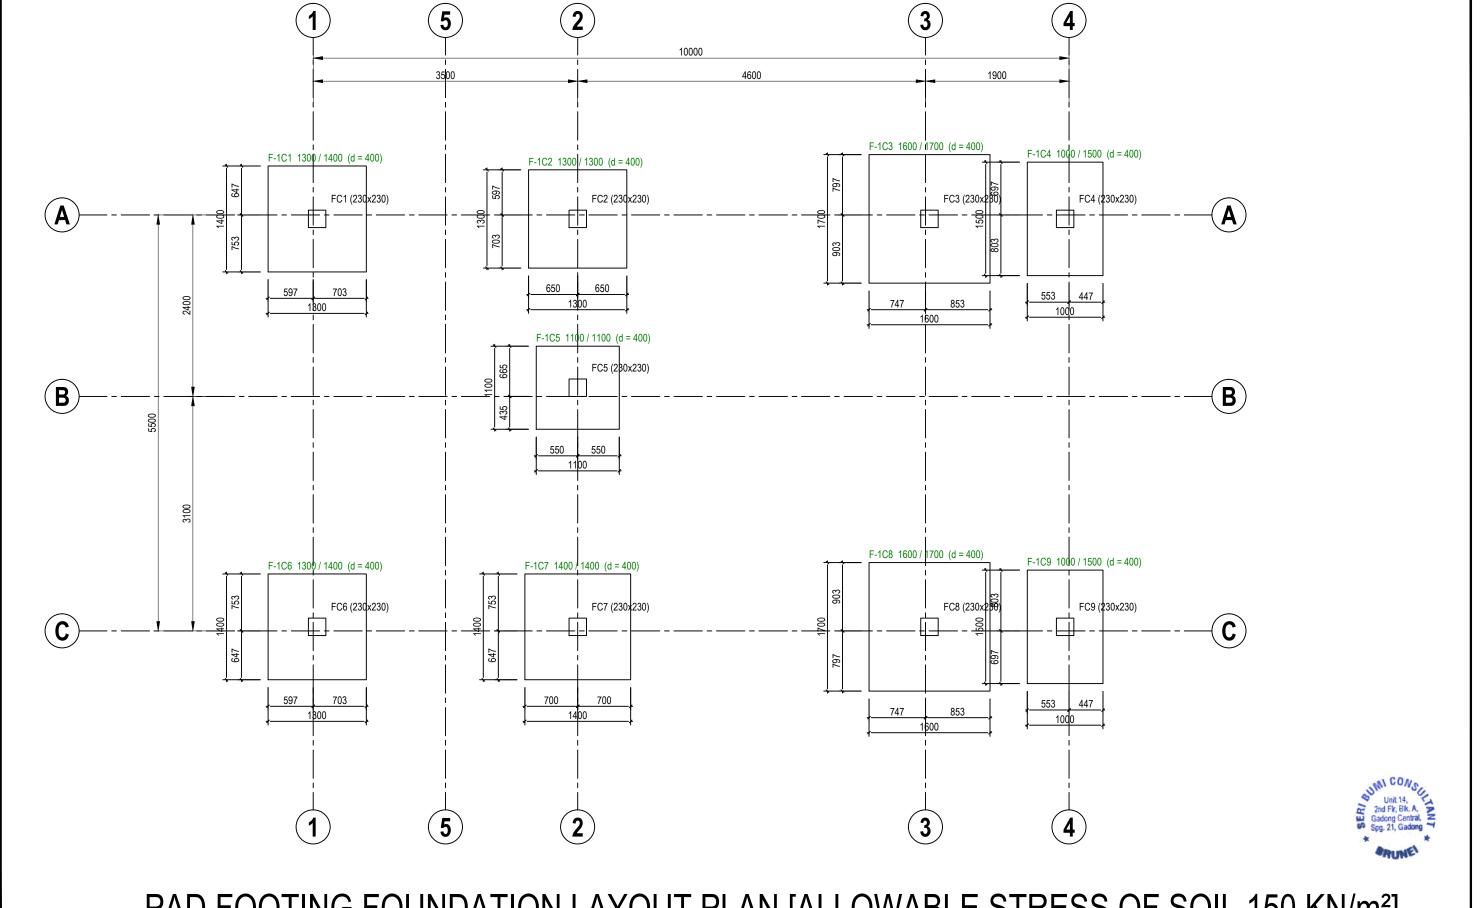


## PAD FOOTING FOUNDATION LAYOUT PLAN [ALLOWABLE STRESS OF SOIL 150 KN/m²]

SCALE 1:75




					DESIGNED BY	THAN ZAW TUN			SCALE:
					DRAWN BY	SAI	1	,	
						<u> </u>	)	-	1
					CHECKED BY	MD. YUNUS			
NO.	NO.	AMENDMENTS	BY	DATE	APPROVED BY		DATE	13/09/2022	
							_		


	TITLE: PAD FOOTING FOUNDATION LAYOUT PLAN (OPTION 2)	JOB NO:			
	[ALLOWABLE STRESS OF SOIL 150KN/m²]	SHEET NO:			
	PROJECT:	DRAWING NO:	REV:		
	PROPOSED NEW 1 UNIT STANDARD DESIGN OF FARM LABOUR QUARTERS, BRUNEI DARUSSALAM (FOR 5 PERSONS) - OPTION 2	SBC/Q366/AFLQ/5PO2/RC/CS -102			

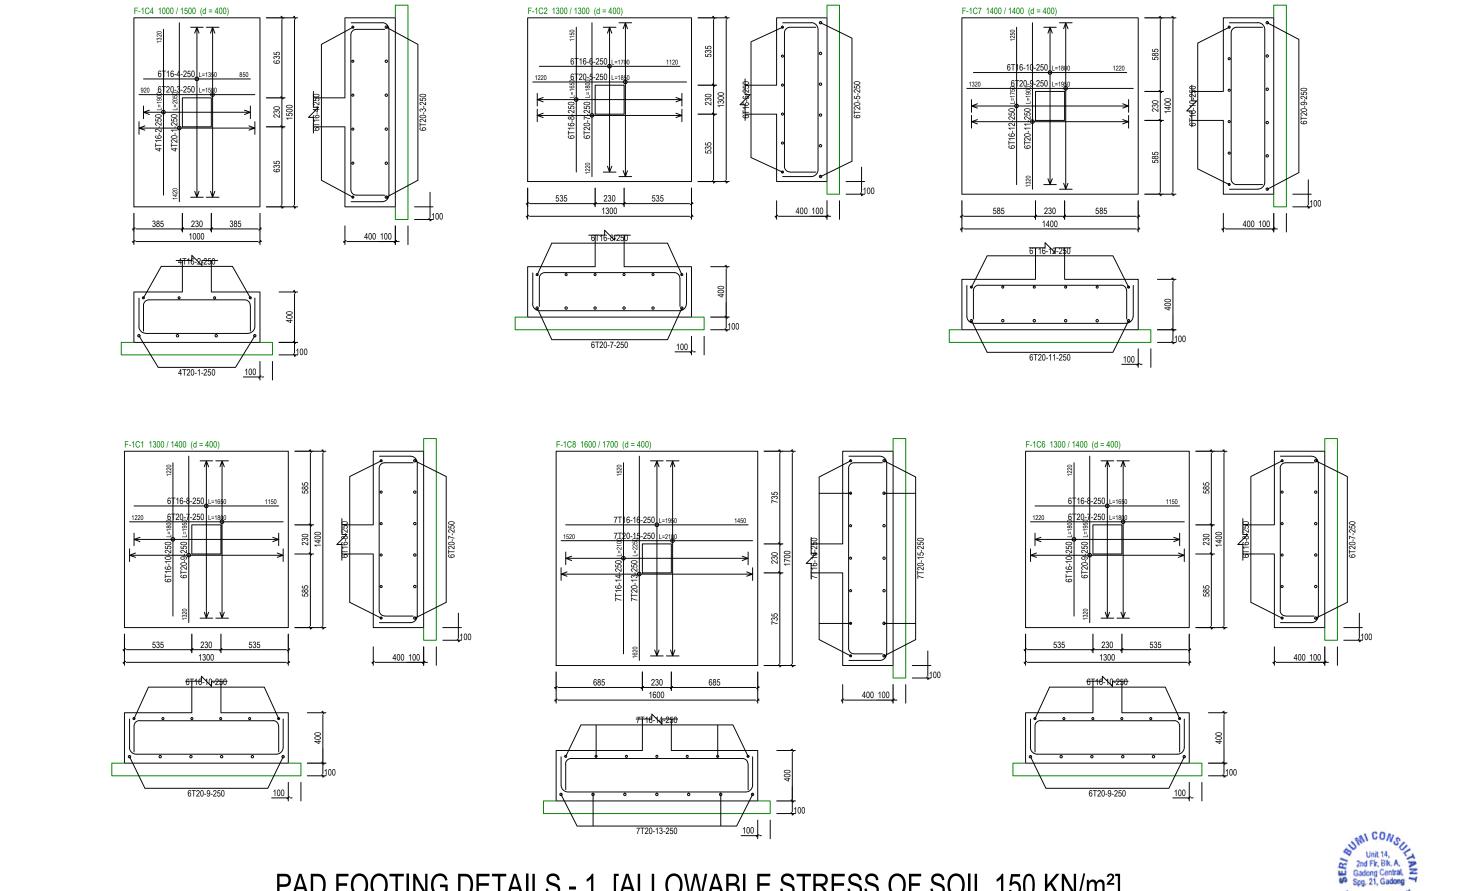



## PAD FOOTING DETAILS - 1 [ALLOWABLE STRESS OF SOIL 150 KN/m²]



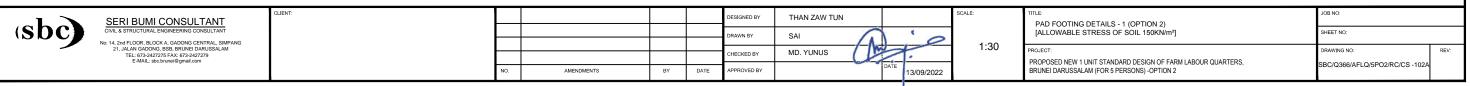

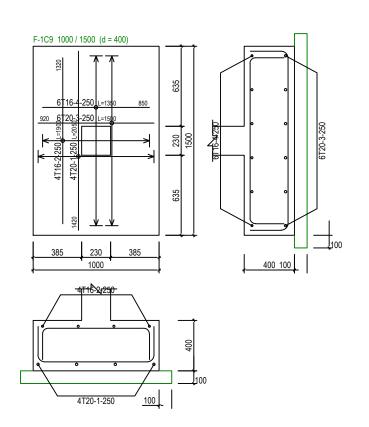

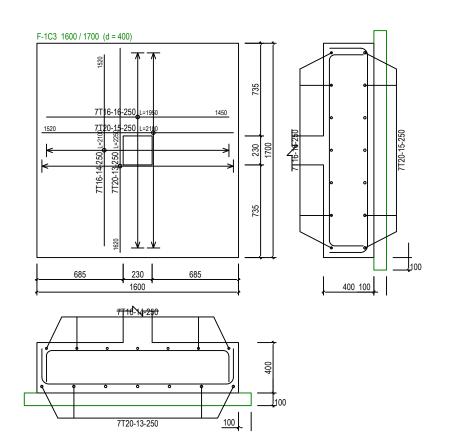


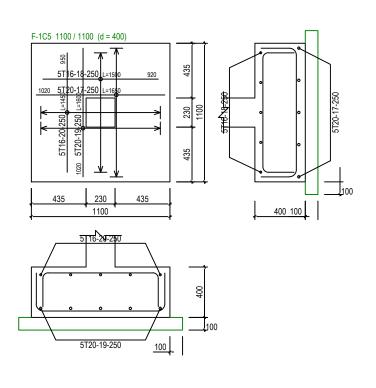

PAD FOOTING DETAILS - 2 [ALLOWABLE STRESS OF SOIL 150 KN/m²] SCALE 1:30





sbc	SERI BUMI CONSULTANT	CLIENT:					DESIGNED BY	THAN ZAW TUN		SCALE:	TITLE: PAD FOOTING DETAILS - 2 (OPTION 2)	JOB NO:
	OIVIL & STRUCTURAL ENGINEERING CONSULTANT  No: 14, 2nd FLOOR, BLOCK A, GADONG CENTRAL, SIMPANG 21, JALAN GADONG, BSB, BRUNEI DARUSSALAM	NTRAL, SIMPANG RUSSALAM	DRAWN BY SAI	1	[ALLOWABLE STRESS OF SOIL 150KN/m²]	SHEET NO:						
						1	MD. YUNUS	7	1:30	PROJECT:	DRAWING NO: REV:	
I	TEL: 673-2427275 FAX: 673-2427279 E-MAIL: sbc.brunei@gmail.com						CHECKED BY	IIIS TORIOS		4	PROPOSED NEW 1 UNIT STANDARD DESIGN OF FARM LABOUR QUARTERS,	SBC/Q366/AFLQ/5PO2/RC/CS -102B
I			NO.	AMENDMENTS	BY	DATE	APPROVED BY	DATE	13/09/2022		BRUNEI DARUSSALAM (FOR 5 PERSONS) -OPTION 2	556,4666,711 24,61 62,716,766 1625

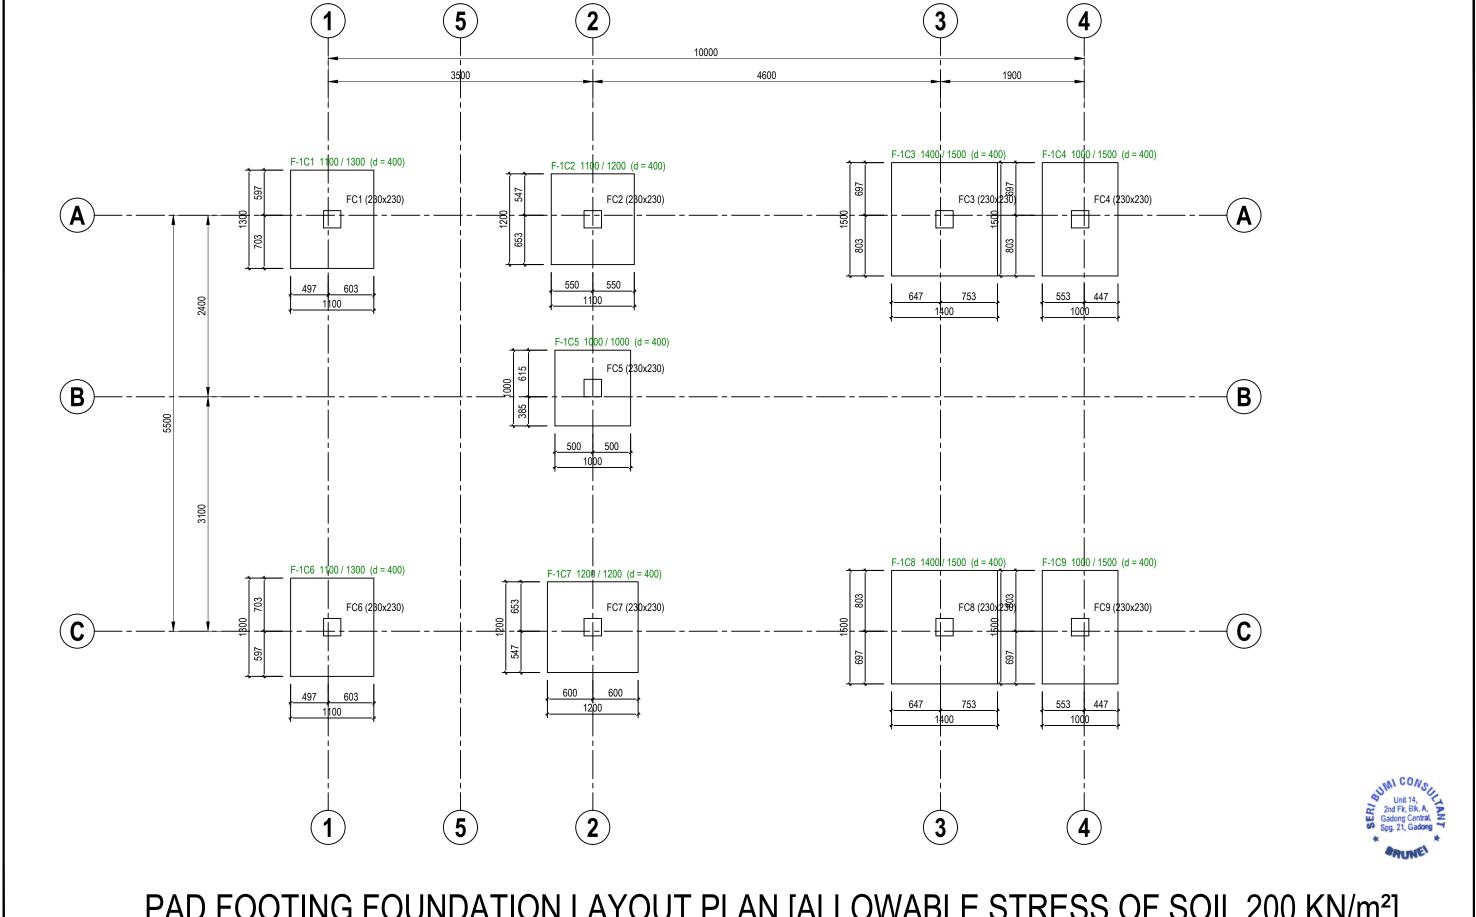

## PAD FOOTING FOUNDATION LAYOUT PLAN [ALLOWABLE STRESS OF SOIL 200 KN/m²]

SCALE 1:75

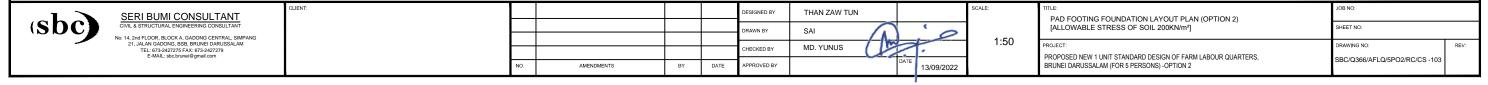

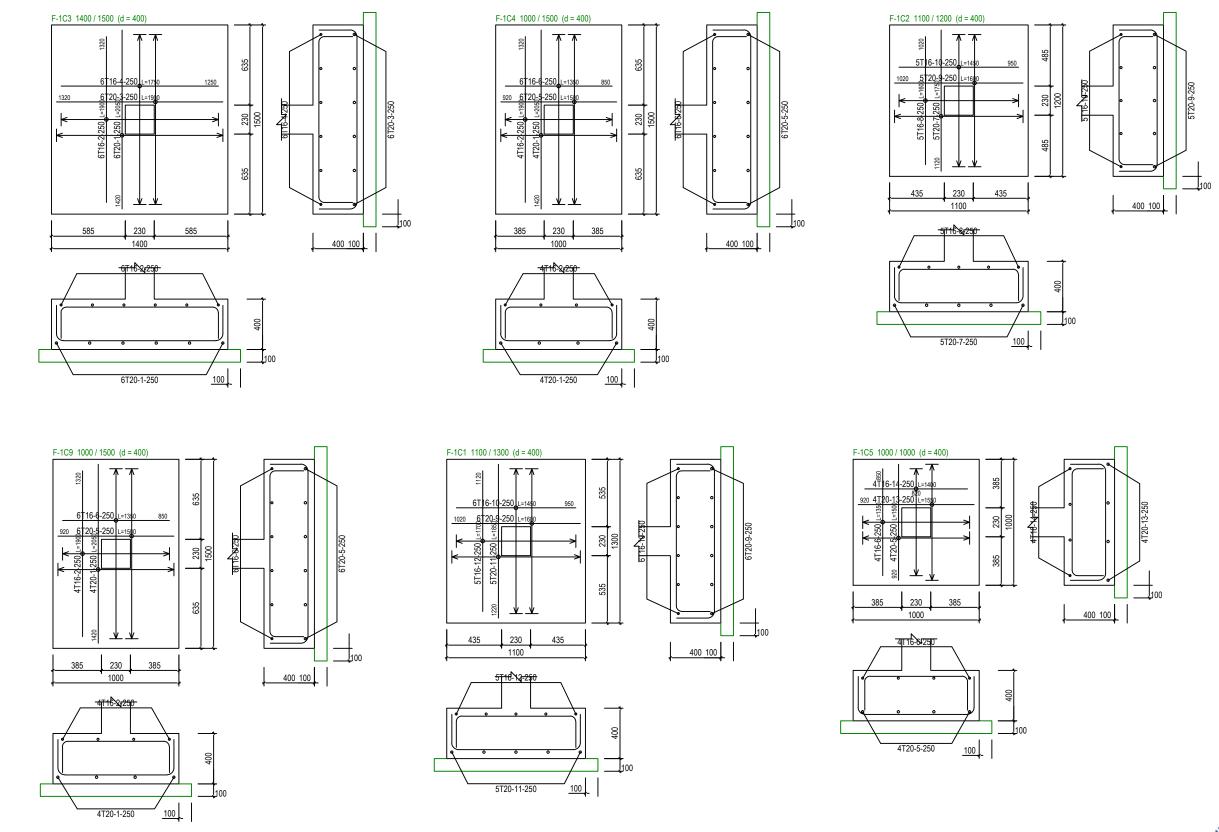


# PAD FOOTING DETAILS - 1 [ALLOWABLE STRESS OF SOIL 200 KN/m²] SCALE 1:30



SERI BUMI CONSULTANT
CIVIL & STRUCTURAL ENGINEERING CONSULTANT
No: 14, 2nd FLOOR, BLOCK A, GADONG CENTRAL SIMPANG
21, JALAN GADONG, BSB, BRUNEI DARUSSALAM
TEL-673-24272779
E-MAIL: sbc.brunei@gmail.com

					DESIGNED BY	THAN ZAW TUN			SCALE
					DRAWN BY	SAI	1	(	
NC						<u> </u>	1	. 0	1
					CHECKED BY	MD. YUNUS			
	NO.	AMENDMENTS	BY	DATE	APPROVED BY		DATE	13/09/2022	


TITLE:	JOB NO:			
PAD FOOTING DETAILS - 1 (OPTION 2)	SHEET NO:			
[ALLOWABLE STRESS OF SOIL 200KN/m²]				
PROJECT:	DRAWING NO:	REV:		
PROPOSED NEW 1 UNIT STANDARD DESIGN OF FARM LABOUR QUARTERS, BRUNEI DARUSSALAM (FOR 5 PERSONS) - OPTION 2	SBC/Q366/AFLQ/5PO2/RC/CS -103A			

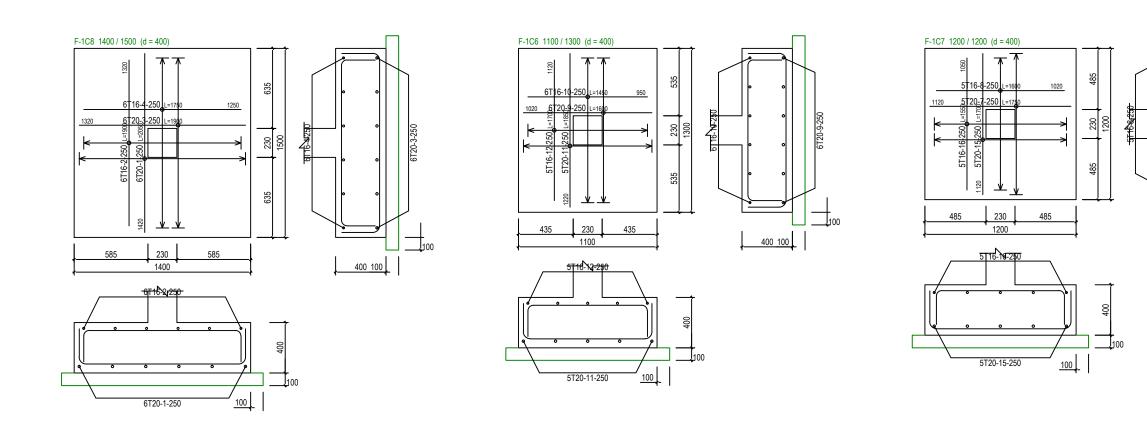



# PAD FOOTING DETAILS - 2 [ALLOWABLE STRESS OF SOIL 200 KN/m²] SCALE 1:30



400 100

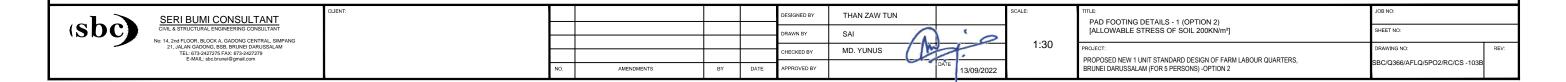

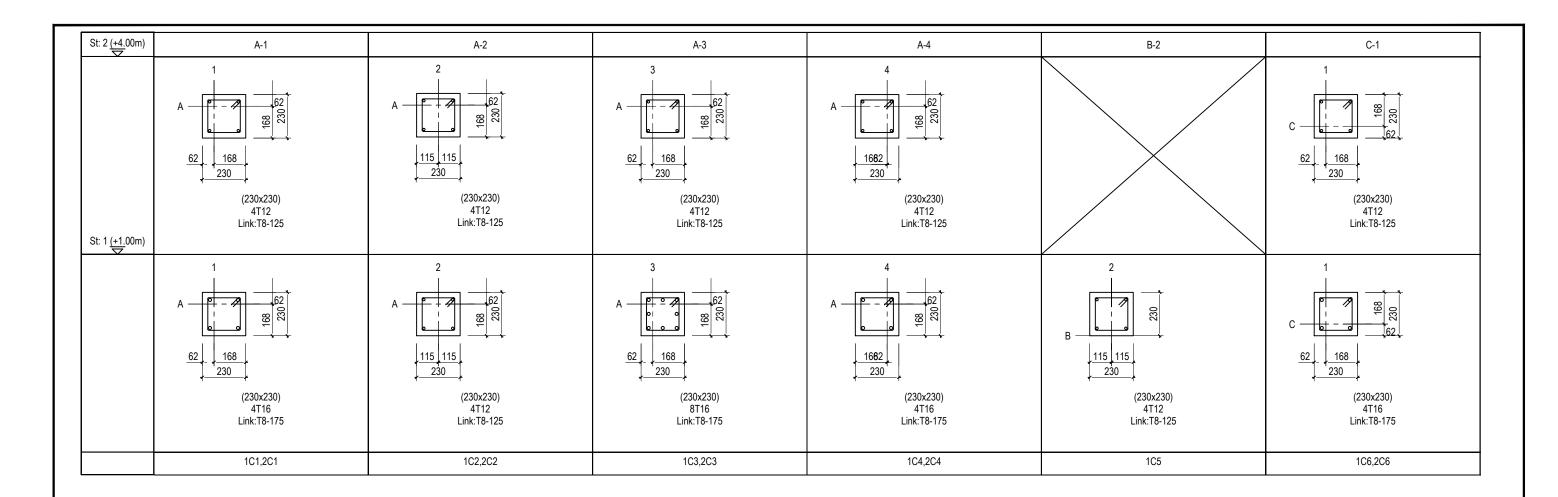

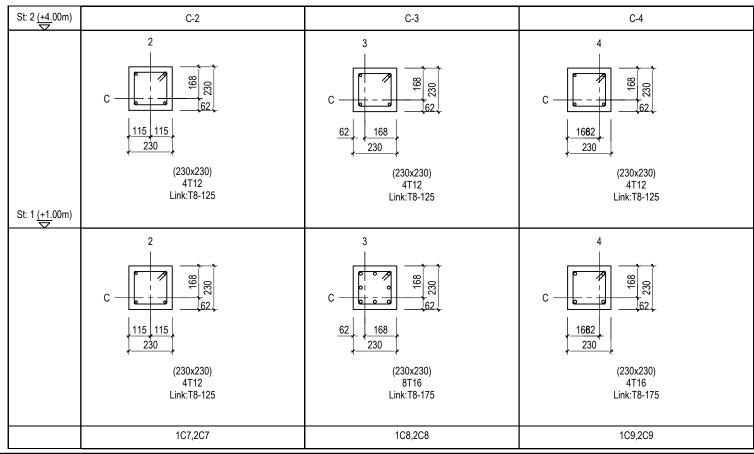



.aL	SERI BUMI CONSULTANT
(SDC)	CIVIL & STRUCTURAL ENGINEERING CONSULTANT
	No: 14, 2nd FLOOR, BLOCK A, GADONG CENTRAL, SIM
	21, JALAN GADONG, BSB, BRUNEI DARUSSALAN
	TEL: 673-2427275 FAX: 673-2427279
	E-MAIL: sbc.brunei@gmail.com

	•						
				DESIGNED BY	THAN ZAW TUN		SCALE
				DRAWN BY	SAI		l
				BIOTHER BY	SAI /		
				CHECKED BY	MD. YUNUS /	W.	l
				OTTE OTTE DE			1
NO.	AMENDMENTS	BY	DATE	APPROVED BY		13/09/2022	

TITLE:

COLUMN SCHEDULE (OPTION 2)

PROJECT:

PROPOSED NEW 1 UNIT STANDARD DESIGN OF FARM LABOUR QUARTERS,
BRUNEI DARRUSSALAM (FOR 5 PERSONS) - OPTION 2

JOB NO:


SHEET NO:

DRAWING NO:

REV:

SBC/Q366/AFLQ/5PO2/RC/CS - 104

N.T.S

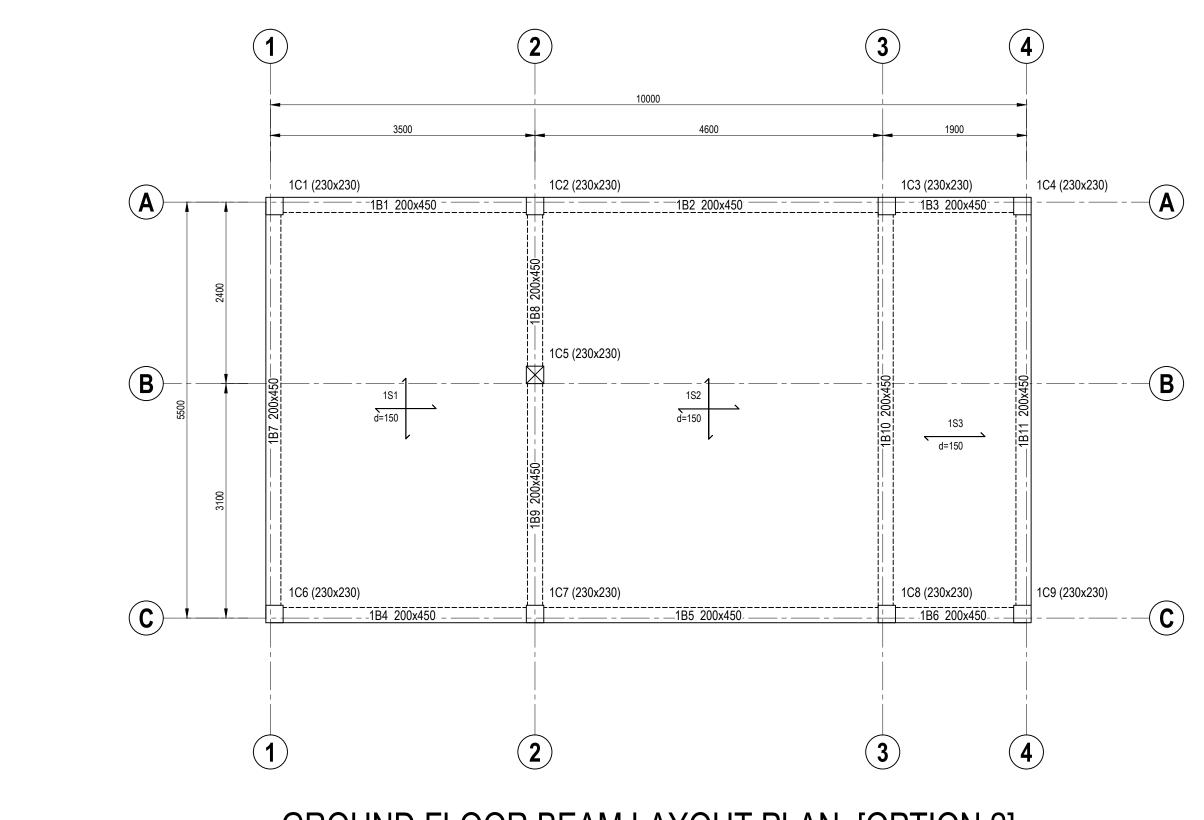



## GROUND FLOOR BEAM LAYOUT PLAN [OPTION 2]

SCALE 1:50



SERI BUMI CONSULTANT	CLIENT:				DESIGNED BY	THAN ZAW TUN		SCALE:	TITLE:	JOB NO:	
(SOC)  CIVILA STRUCTURAL ENGINEERING CONSULTANT  No: 14. 2nd FLOOR, BLOCK A. GADONG CENTRAL SIMPANG					DRAWN BY	SAI	0	1 75	GROUND FLOOR BEAM LAYOUT PLAN (OPTION 2)	SHEET NO:	
21, JALAN GADONG, BSB, BRUNEI DARUSSALAM TEL: 673-2427275 FAX: 673-2427279 E-MAIL: 5bc/bunei@gmail.com	l				CHECKED BY	MD. YUNUS		1.75	PROJECT: PROPOSED NEW 1 UNIT STANDARD DESIGN OF FARM LABOUR QUARTERS.	DRAWING NO: REV:	
		NO.	AMENDMENTS	BY DAT	APPROVED BY		13/09/2022		BRUNEI DARUSSALAM (FOR 5 PERSONS) -OPTION 2	SBC/Q366/AFLQ/5PO2/RC/CS - 200	

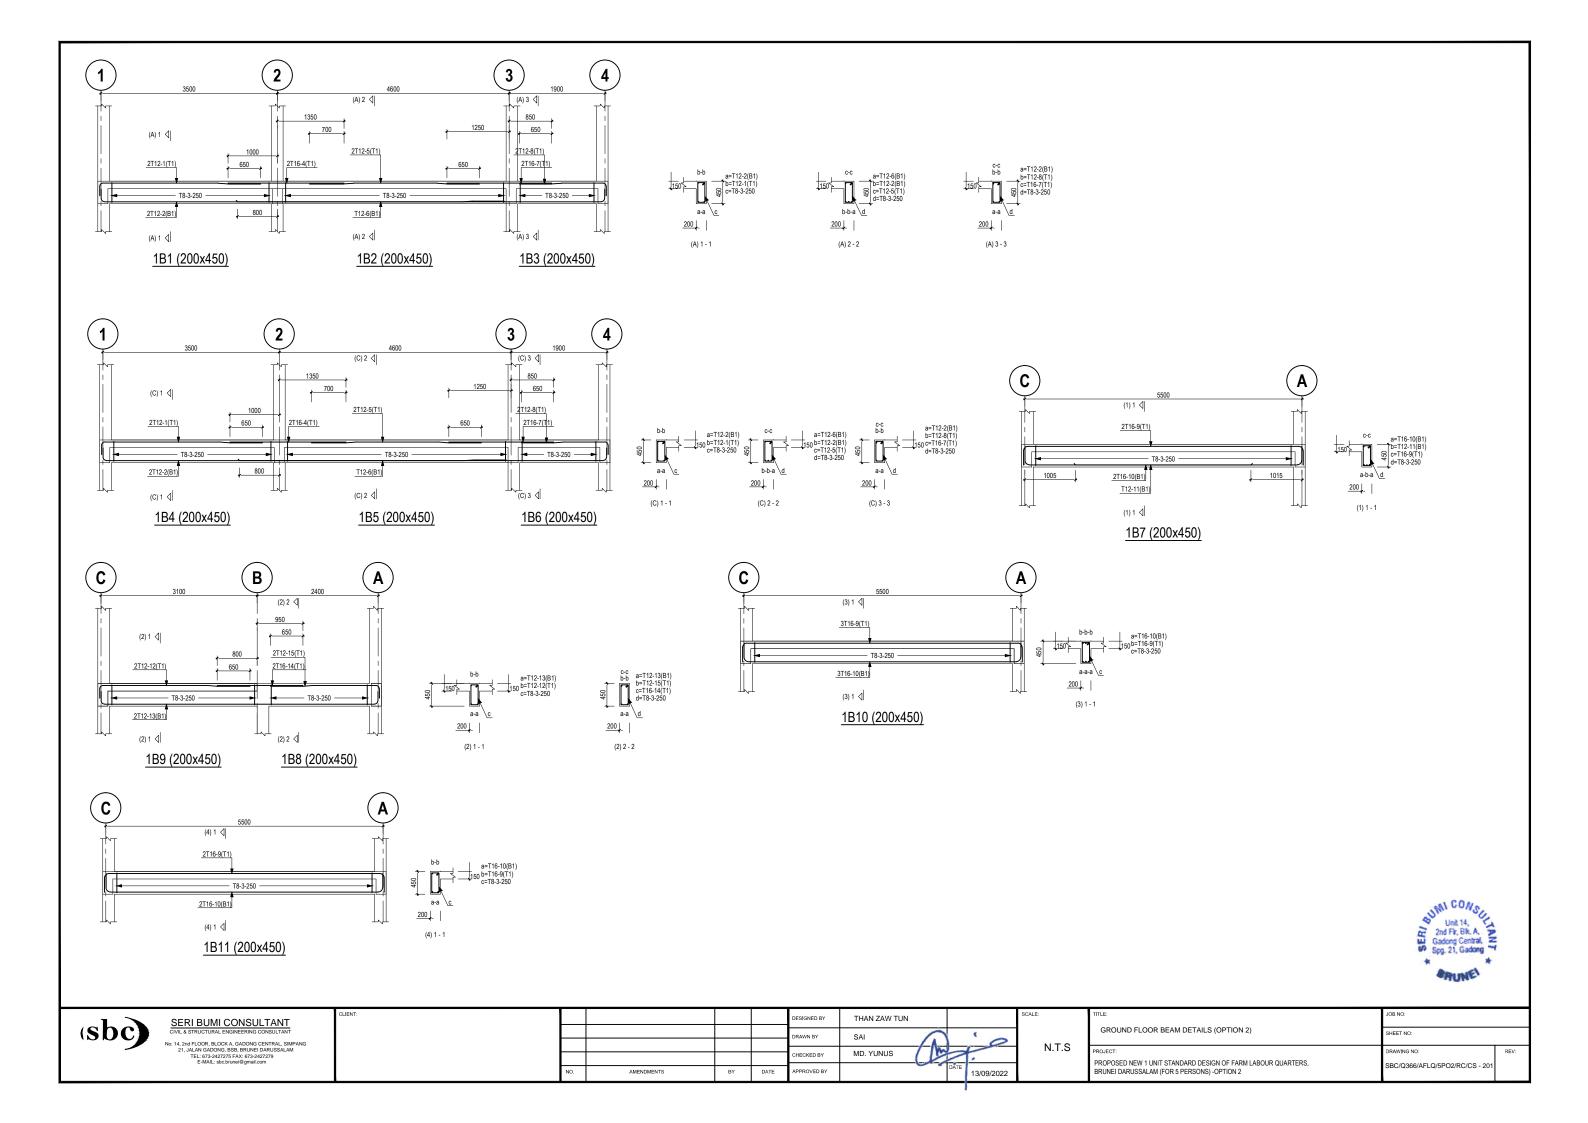

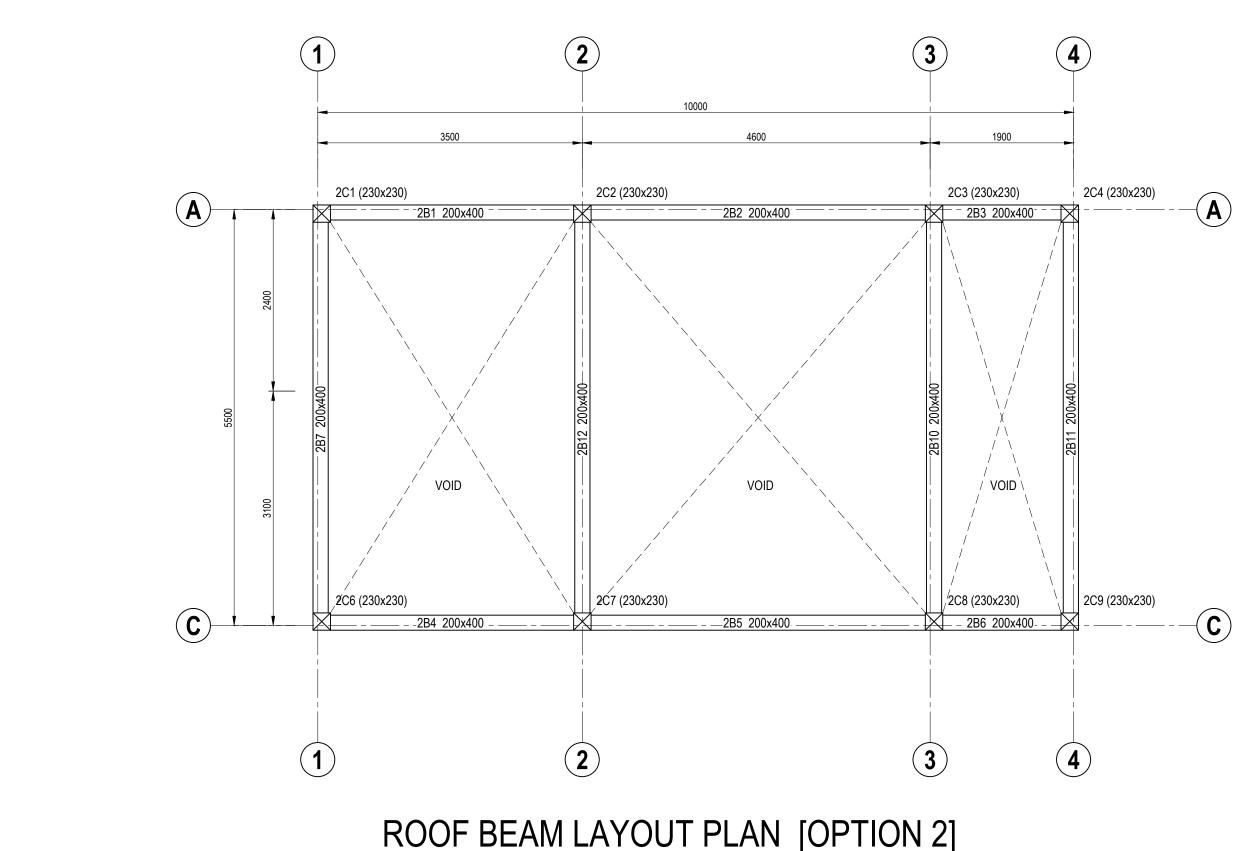



## ROOF BEAM LAYOUT PLAN [OPTION 2]


SCALE 1:50



■ SERI BUMI CONSULTANT	CLIENT:			DESIGNED BY	THAN ZAW TUN		SCALE:	TITLE:	JOB NO:	
(SDC)  CIVIL & STRUCTURAL ENGINEERING CONSULTANT  No. 14, 2nd FLOOR, BLOCK A, GADONG CENTRAL, SIMPANG				DRAWN BY	SAI	10	1	ROOF BEAM LAYOUT PLAN (OPTION 2)	SHEET NO:	
21, JALAN GADONG, BSB, BRUNEI DARUSSALAM TEL: 673-2427275 FAX: 673-2427279 E-MAIL: sbcburneil@gmail.com				CHECKED BY	MD. YUNUS	7.	1:75	PROJECT: PROPOSED NEW 1 UNIT STANDARD DESIGN OF FARM LABOUR QUARTERS,	DRAWING NO:	REV:
		NO. AMENDMENTS	BY DATE	APPROVED BY		13/09/2022		BRUNEI DARUSSALAM (FOR 5 PERSONS) -OPTION 2	SBC/Q366/AFLQ/5PO2/RC/CS - 300	/

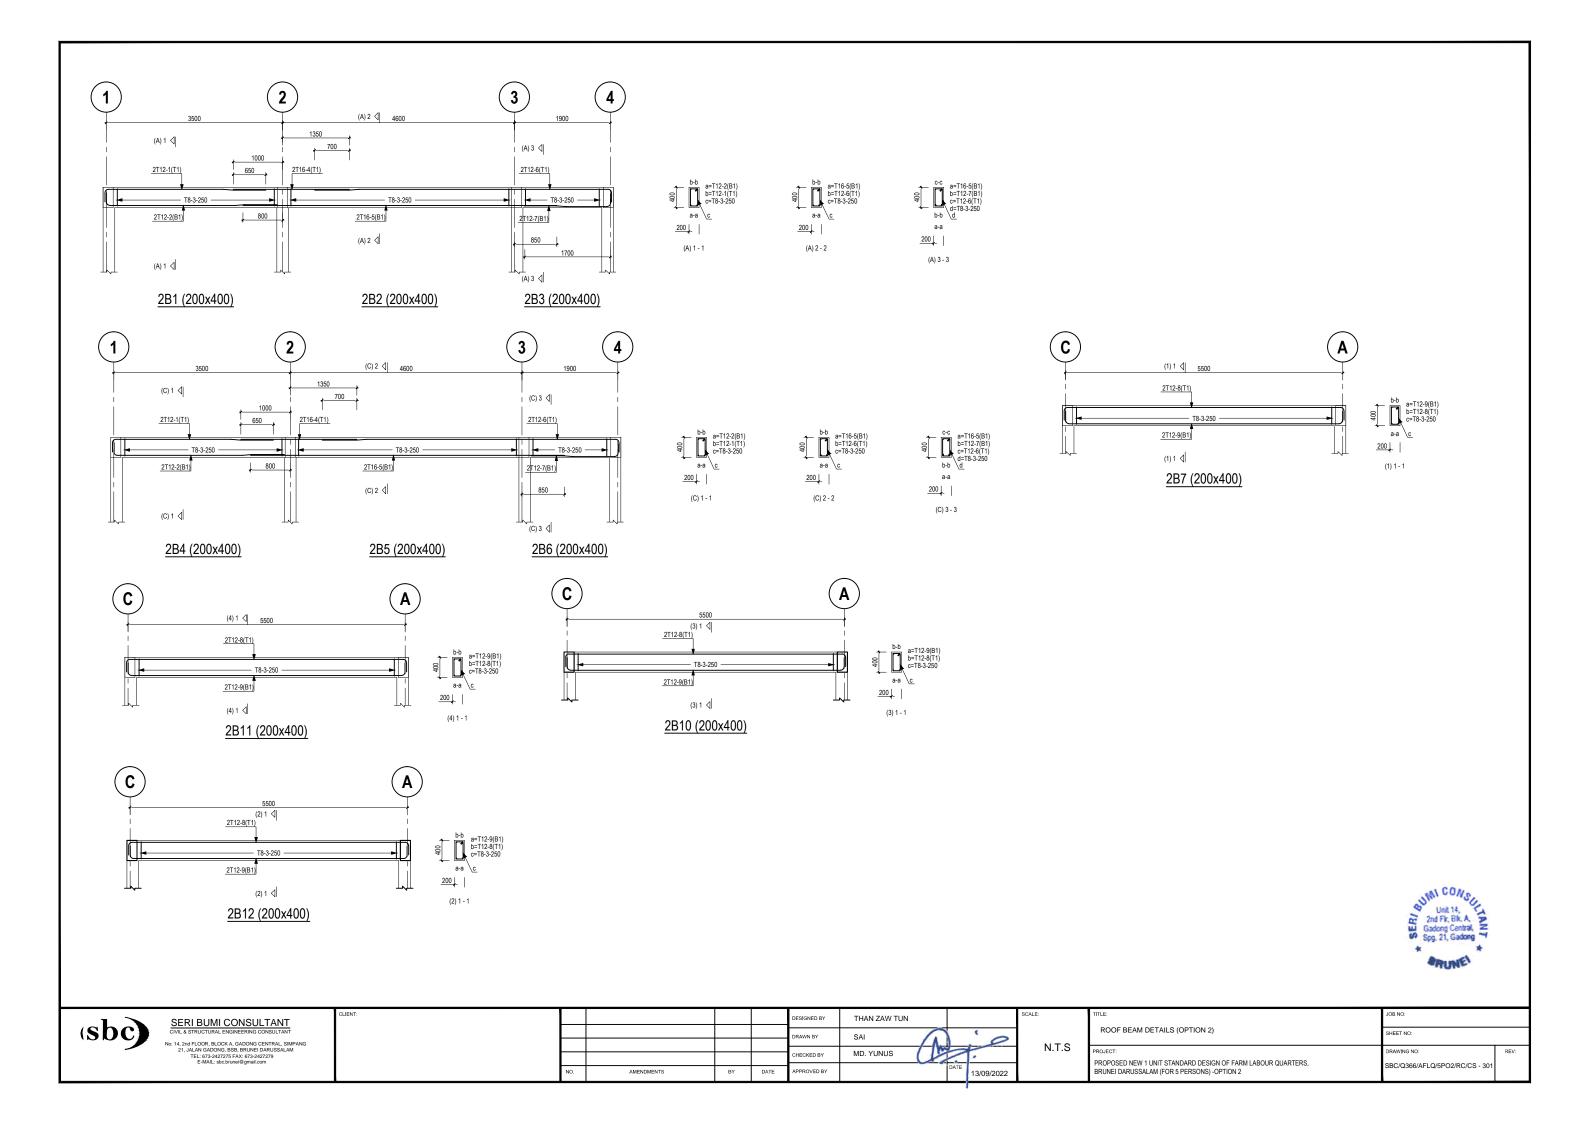

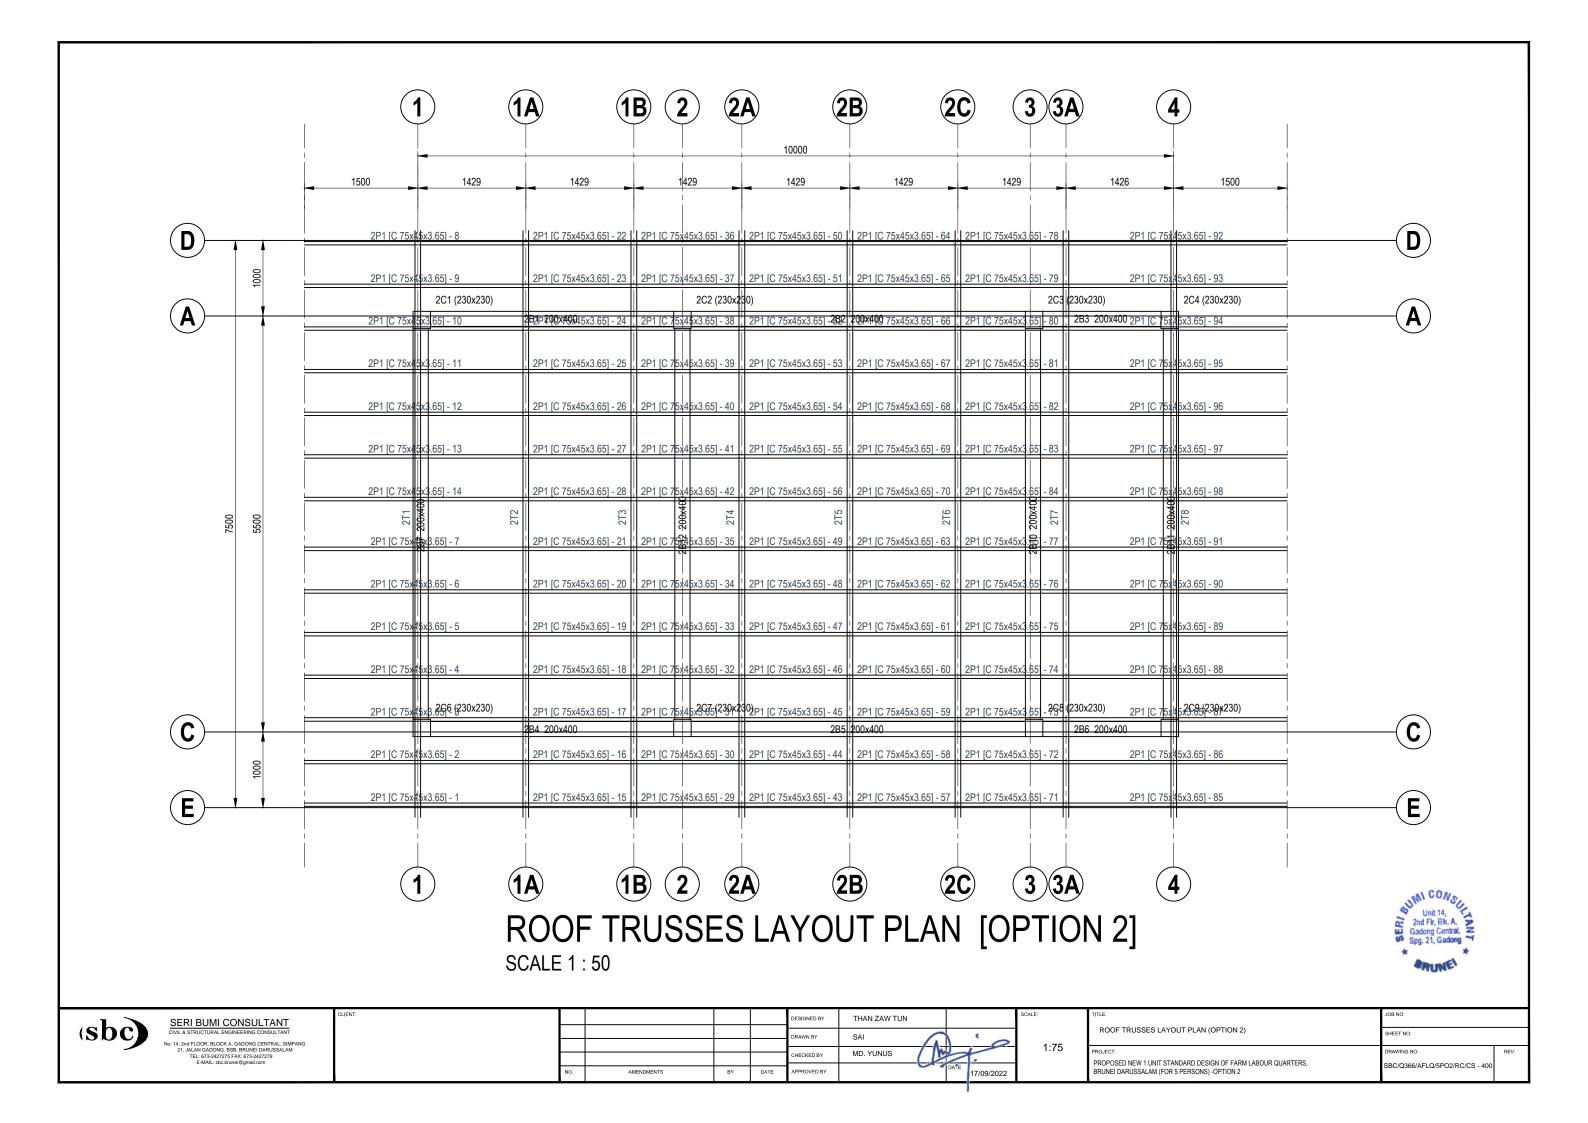


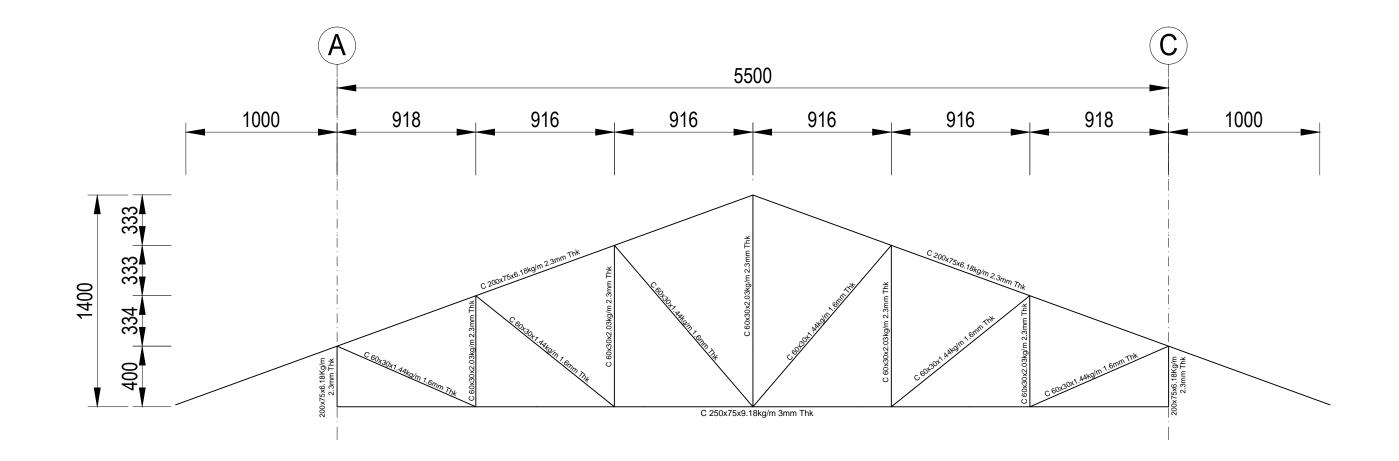



ROOF TRUSS SECTION(FOR ROOF TRUSS TO REINFORCE CONCRETE BEAM CONNECTION)



■ SERI BUMI CONSULTANT	CLIENT:			DESIGNED BY	THAN ZAW TUN		SCALE:	TITLE:	JOB NO:	
(SDC)  CIVIL & STRUCTURAL ENGINEERING CONSULTANT  No: 14, 2nd FLOOR, BLOCK A, GADONG CENTRAL, SIMPANG				DRAWN BY	SAI	' 0	1	ROOF TRUSSES SECTION (FOR ROOF TRUSS TO REINFORCE CONCRETE BEAM CONNECTION)	SHEET NO:	
21, JALAN GADONG, BSB, BRUNEI DARUSSALAM TEL: 673-2427275 FAX: 673-2427279 E-MAIL: sbcburneil@gmail.com			CHECKED BY MD. YUNUS	7.	1:20 PROJECT:	PROJECT: PROPOSED NEW 1 UNIT STANDARD DESIGN OF FARM LABOUR QUARTERS,	DRAWING NO:	REV:		
- · · · · · · · · · · · · · · · · · · ·		NO. AMENDMENTS	BY DATE	APPROVED BY		20/09/2022		BRUNEI DARUSSALAM (FOR 5 PERSONS) - OPTION 2	SBC/Q366/AFLQ/5PO2/RC/CS - 401	/

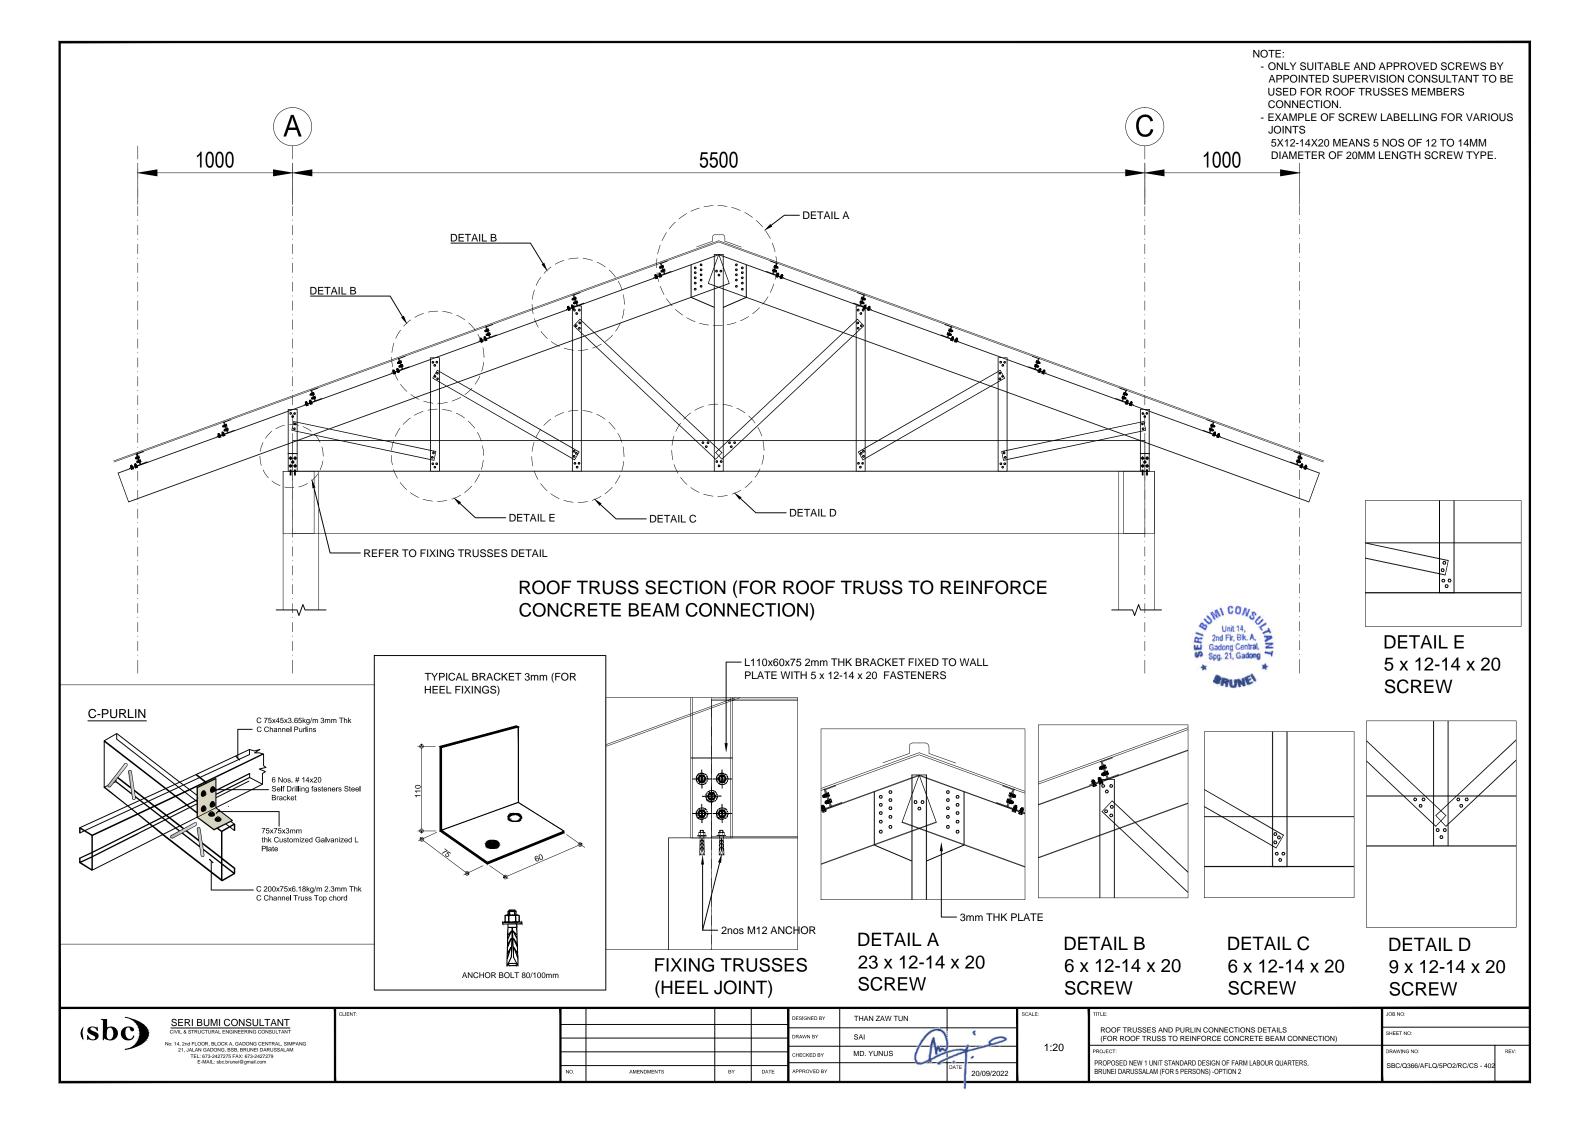

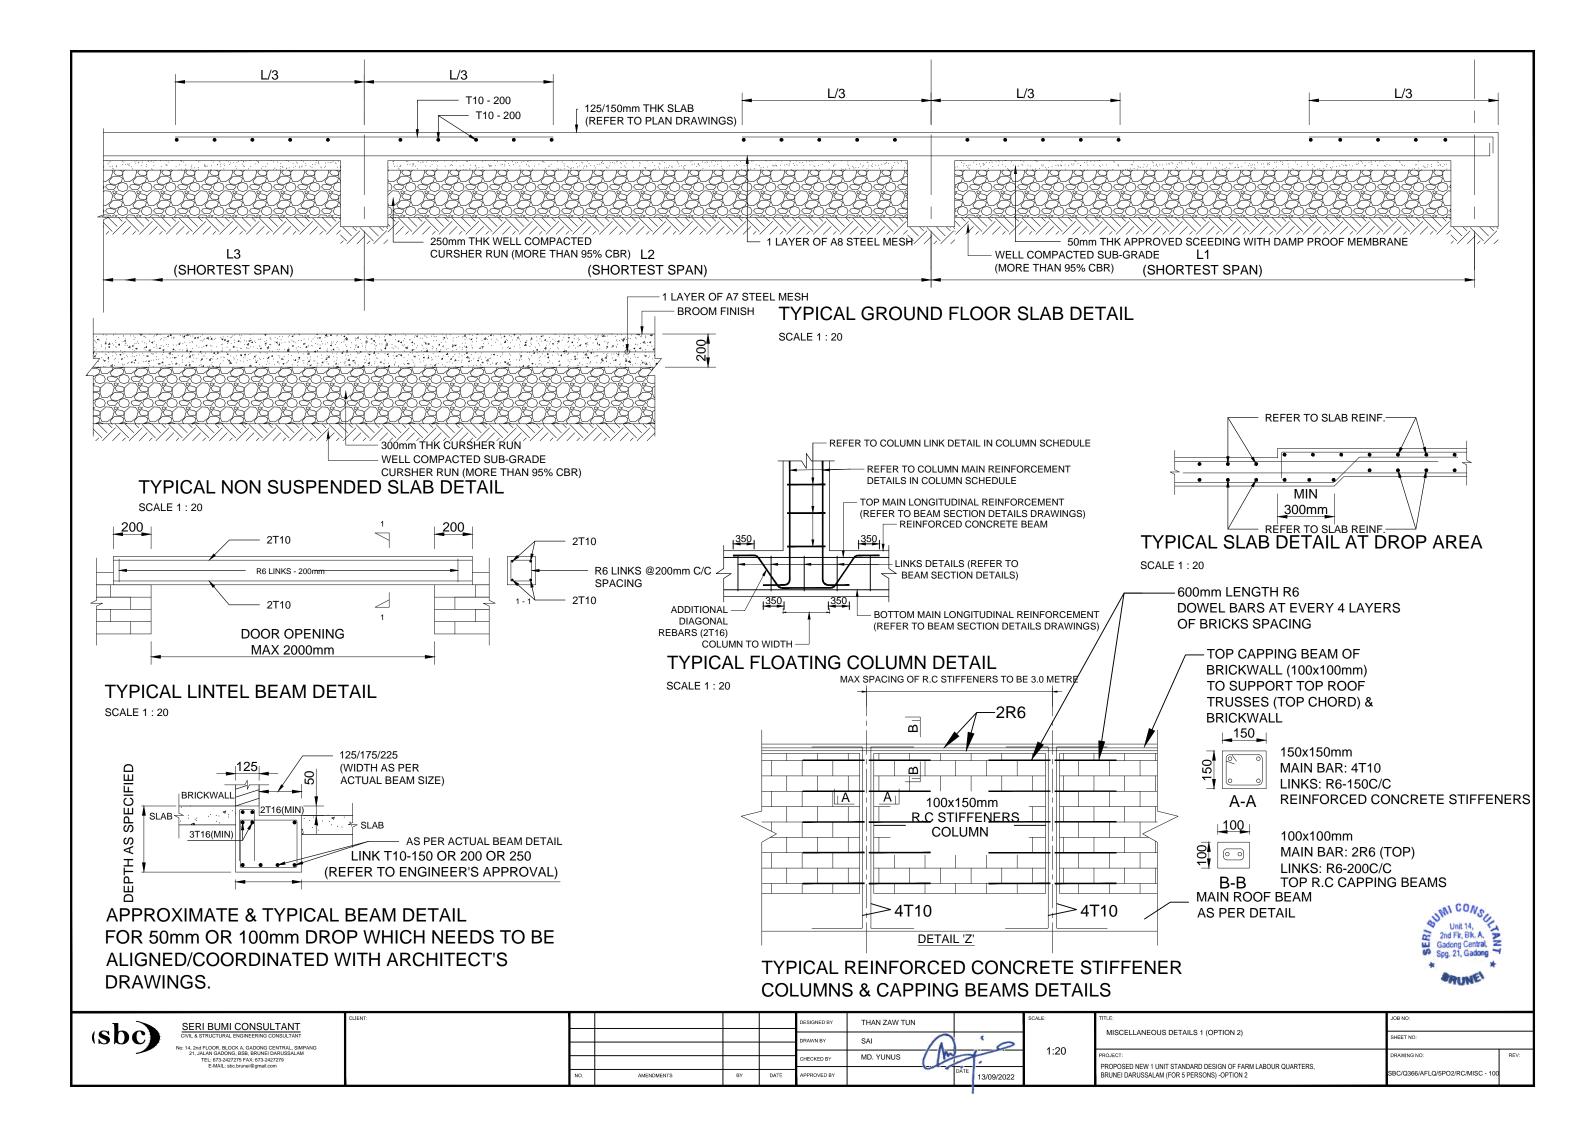

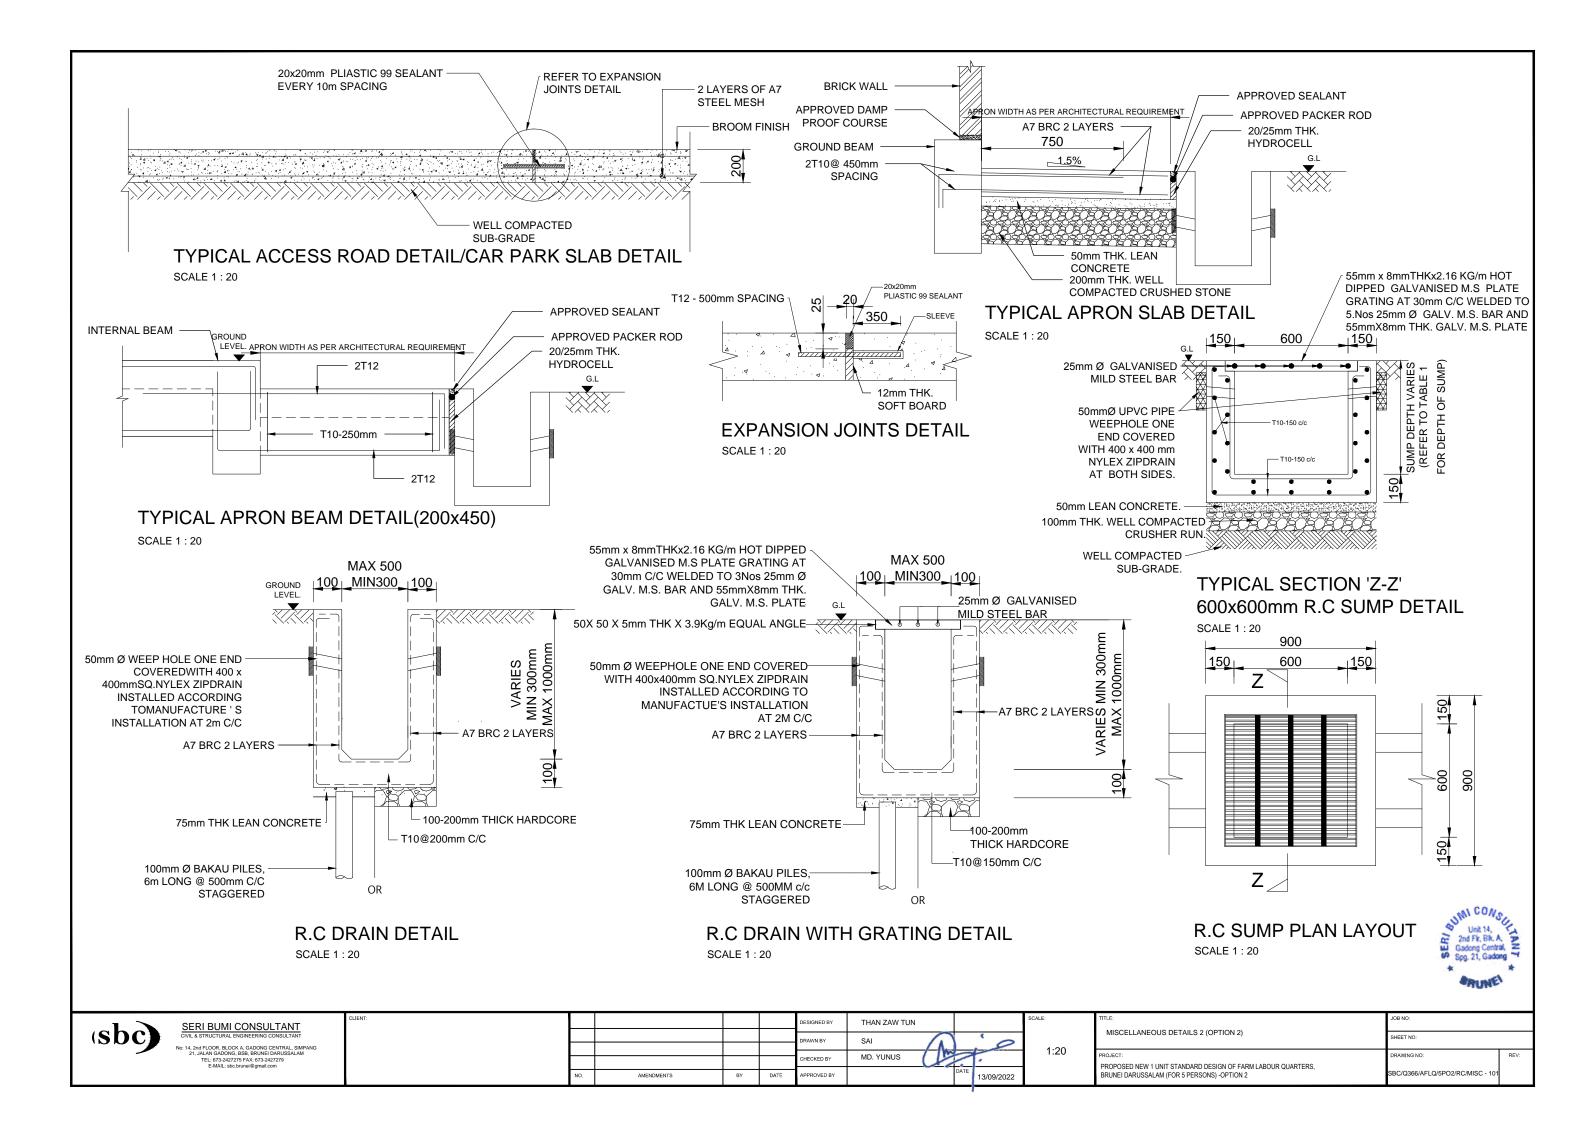

# PROPOSED NEW 1 UNIT STANDARD DESIGN OF FARM LABOUR QUARTERS, BRUNEI DARUSSALAM (FOR 5 PERSONS) -OPTION 2

			LIST OF DR	RAWINGS	
		DESCRIPTIONS	DRAWING NO.	REVISION NO.	REMARKS
(	1	LIST OF DRAWINGS	SBC/Q366/AFLQ/5PO2/ST/L - 100	2	
	2	GENERAL NOTES	SBC/Q366/AFLQ/5PO2/ST/G-100		
	3	150x150mm R.C PRECAST PILE FOUNDATION LAYOUT PLAN	SBC/Q366/AFLQ/5PO2/ST/CS-100		
	4	PAD FOOTING FOUNDATION LAYOUT PLAN [ALLOWABLE STRESS OF SOIL 100 kN/m²]	SBC/Q366/AFLQ/5PO2/ST/CS-101		
,	5	PAD FOOTING DETAILS - 1 [ALLOWABLE STRESS OF SOIL 100 kN/m²]	SBC/Q366/AFLQ/5PO2/ST/CS-101A		
	6	PAD FOOTING DETAILS - 2 [ALLOWABLE STRESS OF SOIL 100 kN/m²]	SBC/Q366/AFLQ/5PO2/ST/CS-101B		
	7	PAD FOOTING FOUNDATION LAYOUT PLAN [ALLOWABLE STRESS OF SOIL 150 kN/m²]	SBC/Q366/AFLQ/5PO2/ST/CS-102		
	8	PAD FOOTING DETAILS - 1 [ALLOWABLE STRESS OF SOIL 150 kN/m²]	SBC/Q366/AFLQ/5PO2/ST/CS-102A		
	9	PAD FOOTING DETAILS - 2 [ALLOWABLE STRESS OF SOIL 150 kN/m²]	SBC/Q366/AFLQ/5PO2/ST/CS-102B		
1	10	PAD FOOTING FOUNDATION LAYOUT PLAN [ALLOWABLE STRESS OF SOIL 200 kN/m²]	SBC/Q366/AFLQ/5PO2/ST/CS-103		
1	11	PAD FOOTING DETAILS - 1 [ALLOWABLE STRESS OF SOIL 200 kN/m²]	SBC/Q366/AFLQ/5PO2/ST/CS-103A		
1	12	PAD FOOTING DETAILS - 2 [ALLOWABLE STRESS OF SOIL 200 kN/m²]	SBC/Q366/AFLQ/5PO2/ST/CS-103B		
1	13	COLUMN SCHEDULE	SBC/Q366/AFLQ/5PO2/ST/CS-101		
1	14	GROUND FLOOR BEAM LAYOUT PLAN	SBC/Q366/AFLQ/5PO2/ST/CS-200		
1	15	GROUND FLOOR BEAM DETAILS	SBC/Q366/AFLQ/5PO2/ST/CS-201		
1	16	ROOF BEAM LAYOUT PLAN	SBC/Q366/AFLQ/5PO2/ST/CS-300		
1	17	ROOF TRUSSES LAYOUT PLAN	SBC/Q366/AFLQ/5PO2/ST/CS-400		
		ROOF TRUSSES SECTION (FOR ROOF TRUSS TO STEEL BEAM CONNECTION)	SBC/Q366/AFLQ/5PO2/ST/CS-401	}	
$\left\{ \left[ 1\right] \right\}$		(FOR ROOF TRUSS TO STEEL BEAM CONNECTION)	SBC/Q366/AFLQ/5PO2/ST/CS-402	}	. 66-
2	20	MISCELLANEOUS DETAILS - 1	SBC/Q366/AFLQ/5PO2/ST/MISC-100		Unit 14,
2	21	MISCELLANEOUS DETAILS - 2	SBC/Q366/AFLQ/5PO2/ST/MISC-101		Sadiong Central, Spg. 21, Gadong T

1 >	SERI BUMI CONSULTANT	CLIENT:					DESIGNED BY	THAN ZAW TUN		SCALE:	TITLE:	JOB NO:	
(Sbc)	CIVIL & STRUCTURAL ENGINEERING CONSULTANT  No: 14, 2nd FLOOR, BLOCK A, GADONG CENTRAL, SIMPANG						DRAWN BY	SAI	1.0		LIST OF DRAWINGS	SHEET NO:	
	11, Jalan Gadong, BSB, BRUNEI DARUSSALAM TEL: 673-2427275 FAX: 673-2427279 E-MAIL: sbc.brunei@gmail.com						CHECKED BY	MD. YUNUS		N.T.S	PROJECT: PROPOSED NEW 1 UNIT STANDARD DESIGN OF FARM LABOUR QUARTERS,		REV:
			NO.	AMENDMENTS	BY	DATE	APPROVED BY	,	20/09/2022		BRUNEI DARUSSALAM (FOR 5 PERSONS) -OPTION 2	SBC/Q366/AFLQ/5P/ST/L - 100	2

### GENERAL

- 1.1 SETTING OUT:
  - ALL DIMENSIONS MEASURED ON SITE SHALL BE CHECKED AND CONFIRMED WITH RELEVANT ARCHITECTURAL, M&E, CIVIL AND STRUCTURAL DRAWINGS.
- 1.2 ANY DISCREPANCIES BETWEEN ARCHITECTURAL, C&S AND M&E DRAWINGS SHALL BE REFERRED TO PROJECT ARCHITECT OR STRUCTURAL ENGINEER OR
- 1.3 PLEASE NOTE THAT THE ARCHITECTURAL DRAWINGS GRID LINE AND STRUCTURAL DRAWINGS GRID LINES HAVE BEEN PURPOSELY OFF-SET TO EASE CONSTRUCTION ON STRUCTURAL MEMBERS.
- 2. STANDARDS & CODE OF PRACTICE
- 2.1 BS 8110 : 1985 STRUCTURAL USE OF CONCRETE
  2.2 PBD 12 : 2008 BUILDING GUIDELINES AND REQUIREMENTS
- 2.3 BS 4449: 1978 HOT ROLLED STEEL BARS FOR THE REINFORCEMENT OF CONCRETE
- 3. CONCRETE
- 3.1 CONCRETE STRENGTH: 25 N/mm² (GRADE 25) UNLESS OTHERWISE
  - STATED LEAN CONCRETE - 15 N/mm<sup>2</sup> - 25 N/mm<sup>2</sup> COLUMN - 25 N/mm<sup>2</sup> 25 N/mm<sup>2</sup>
- 3.2 CONCRETE COVER TO ALL REINFORCEMENT INCLUDING LINKS SHALL MEET THE 2-HOUR FIRE RATING & AS STATED BELOW (UNLESS OTHERWISE STATED)
  - COLUMNS: 30mm BEAMS PILE CAPS : 75mm
- 3.3 CONCRETE CURING: TO BE CARRIED OUT BY SPRAYING WITH WATER AND COVERING WITH EITHER GUNI SACKS OR PLASTIC
- 3.4 ANY COLD JOINTS AND HACKED CONCRETE SURFACE SHALL BE APPLIED WITH APPROVED BONDING AGENT BEFORE POURING NEW
- 3.5 50mm (MINIMUM) THICK BLINDING LEAN CONCRETE SHALL BE PROVIDED BENEATH FOOTINGS, GROUND BEAMS AND ALL GROUND FLOOR SLABS
- 4. STEEL REINFORCEMENT
- 4.1 THE MINIMUM YIELD STRENGTH OF STEEL REINFORCEMENT (WITH DENOTATION "T")FOR HIGH TENSILE DEFORMED BAR(TYPE 2 - 460 N/mm², STEEL FABRIC - 485 N/mm² (UNLESS OTHERWISE STATED.
- 4.2 THE MINIMUM YIELD STRENGTH OF STEEL REINFORCEMENT
- 5. ALL WATER RETAINING STRUCTURE OR WET AREAS SHALL BE
- 6. IF REQUIRED R.C LINTEL BEAM OF SIZES 150 X 200 REINFORCED WITH 2T12 (T&B) & R6 -150 LINKS SHALL BE PROVIDED TO ALL DOORS AND WINDOWS. STIFFENER, COLUMN SIZES 150X150 TO 200X200 REINFORCED WITH 4T12 & T10-150 LINKS SHALL BE PROVIDED IF REQUIRED. (FOR EG. ON WALL OF MORE THAN 3.5m IN HORIZONTAL LENGTH OR
- 7. INCORPORATING OF M & E REQUIREMENTS IN STRUCTURAL DRAWINGS: THE CONTRACTOR TO PREPARE DETAILED SHOP DRAWINGS INCORPORATING ALL M & E. REQUIREMENTS, OPENINGS ETC INTO THE STRUCTURAL DRAWINGS AND OBTAIN THE PROJECT STRUCTURAL ENGINEER APPROVAL BEFORE PROCEEDING WITH ANY FORM OF PERMANENT CONSTRUCTION WORKS. THE CONTRACTOR SHALL RESOLVE ALL DISCREPANCIES WITH ENGINEERS REGARDING M & E WORKS PRIOR TO CONCRETING.

# 8. NOTES FOR COMPACTION WORKS OF SUB-BASE AND SUB-GRADE.

- ALL SUB-GRADE AND SUB-BASE LAYING WORKS SHALL BE WELL COMPACTED TO OVER 95% CBR.
- MINIMUM OF FOUR NUMBER OF DRY FIELD DENSITY TESTS AND CBR TESTS SHALL BE CONDUCTED ON COMPACTED SUBGRADES AND SUB-BASE BEFORE CARRYING OUT ANY PERMANENT WORKS SUCH AS CONCRETING OF ACCESS ROAD, GARAGE NON-SUSPENDED FLOOR SLABS & HARD STANDINGS, ETC. THE TESTS RESULTS SHALL BE SUBMITTED TO CIVIL AND STRUCTURAL CONSULTANT ENGINEER FOR REVIEW AND APPROVAL TO PROCEED WITH PERMANENT WORKS (IF APPLICABLE BASIS ONLY).

# 9.REMOVAL OF FORMWORK

A) THE TIME FOR THE REMOVAL OF FORMWORKS IS TO BE SUBJECTED TO ENGINEER'S APPROVAL BLE UNDER NORMAL CIRCUMSTANCES

Е	BUT THE FOLLOWING MAY BE TAKEN AS A GU	JIDE TO MINIMUM	TIMES APPLICAB
	SIDE OF COLUMNS/PIERS,WALLS AND BEAMS	3 DAYS	
	SOFFIT OF SLABS (PROPS LEFT UNDER)	14 DAYS	
	PROPS OF SLABS	28 DAYS	
	SOFFIT OF BEAMS ( PROPS LEFT UNDER)	14 DAYS	
	PROPS TO SOFFIT OF BEAMS	28 DAYS	

- B) SHUTTERING AND CENTERING SHALL BE REMOVED BY GRADUAL EASING WITHOUT JARRING, AND ONLY IN THE PRESENCE OF A COMPETENT SUPERVISER, BEFORE REMOVAL OF THE SHUTTERING, THE CONCRETE SHALL BE EXAMINED, AND REMOVAL SHALL PROCEED ONLY IF THE CONCRETE HAS ATTAINED SUFFICIENT STRENGTH TO SUPPORT ITS OWN WEIGHT AND ANYCONSTRUCTIONAL OR OTHER LOADS LIKELY TO COME UPON IT. IF ANY LOADING IN EXCESS OF THE DESIGN LOAD IS ANTICIPATED, APPROVED PROPS SHALL BE PROVIDED AFTER REMOVAL OF SHUTTERING
- C) TO ENSURE THAT THE CONSTRUCTIONAL LOADS OF A FLOOR ARE SHARED BY AT LEAST TWO FLOORS BELOW IT, THE PROPS TO THE BEAMS AND SLABS OF A FLOOR SHALL NOT BE REMOVED UNTIL THE FLOOR ABOVE THE FLOOR IN QUESTION, IS STRONG ENOUGH TO SUPPORT ITSELF.

# 10. GENERAL NOTES FOR PILING WORKS

- ALL PILES TO BE USED FOR THIS PROJECT SHALL BE OF BRUNEI DARUSSALAM MINISTRY OF DEVELOPMENT'S APPROVED TYPES AND BRAND NAMES OR AS PER S.O.'S APPROVAL.
- THE CONTRACTOR SHALL SUBMIT TO THE ENGINEER FOR APPROVAL, BEFORE ANY PILING WORK IS STARTED, DETAILS OF :-
- PILE DRIVER INCLUDING SIZE OF HAMMER AND DROP
- CONTRACTOR'S CALCULATIONS OF SETS, CALCULATED USING THE HILEY FORMULA.
- PROPOSED PROGRAM AND SEQUENCE OF PILE DRIVING INCLUDING
- NO PILING SHALL COMMENCE UNTIL THE SET VALUES SUBMITTED BY THE CONTRACTOR
- ARE APPROVED IN WRITING BY THE ENGINEER.
  THE CALCULATED SETS SHALL ONLY BE USED AS A GUIDE FOR DRIVING AND THE SET SHALL BE CONFIRMED BY THE IN-SITU PILE TEST.
- HOWEVER, PILE HYDRAULIC JACKING TO TWICE THE SAFE WORKING LOAD (MINIMUM) SHALL BE USED IF PILE HAMMERING ACTIVITIES CAUSES DISTURBANCES AND DISTRESS (EXCESSIVE VIBRATIONS) TO SURROUNDING BUILDINGS

# 11. GENERAL NOTES FOR R.C PILES

### R.C PILES

- ALL REINFORCED CONCRETE (R.C.) PRECAST PILES SHALL BE 150MM X 150MM REINFORCED CONCRETE PRECAST PILES OR AS PER SPECIFIED IN THE DRAWINGS
- CONCRETE GRADE SHALL BE GRADE 45 MINIMUM FOR NORMAL R.C. PRECAST PILES.
- THE ALLOWABLE SAFE BEARING CAPACITY OF EACH R.C. PRECAST PILES POIN SHALL BE 25 TONNES.
- THE EXPECTED PENETRATION DEPTH OF EACH PILE POINT IS 6 TO 15 METRES. THIS IS TO BE CONFIRMED DURING PILE DRIVING WORKS. (UNTIL PILE SET IS ACHIEVED UNLESS OTHERWISE STATED)
- THE PILE SET SHOULD BE ACHIEVED WITH THE LAST 10 BLOWS FOR LESS THAN 20mm PENETRATION (PILE HAMMER OF ABOUT ONE TONNE WITH HAMMER DROP OF ABOUT 600mm TO ONE METRE)
- ALL WELDING WORKS FOR JOINING OF PILES SHALL BE CARRIED OUT BY QUALIFIED LICENSED WELDERS
- IF ANY OF THE PILE POINTS DOES NOT PENETRATE 6 METRES DEEP INTO THE GROUND (IF PILE SET IS ACHIEVED AT LESS THAN 6 METRES PENETRATION LENGTH). THE CLIENT OR CONTRACTOR SHALL REPORT TO THE C&S CONSULTANT FOR REDESIGN REQUIREMENT OF THE PILE FOUNDATION.

# 11a. MILD STEEL TUBULAR PILING

- 11a.1 ALL PILES SHALL BE GRADE 43 SEAMLESS MS TUBES 114.3mm  $\varnothing$  x 6.3mm THICK TO B.S. 4848 PART II WITH AN ULTIMATE LOAD CAPACITY OF NOT LESS THAN 240kN.
- 11a.2 ALL PILING WORK SHALL BE CARRIED OUT IN ACCORDANCE TO THE GENERAL SPECIFICATION AS SHOWN IN SPECIFICATION OF MATERIALS AND WORKMANSHIP

# 12. NOTES FOR PAD FOOTING

- ALL PAD FOOTING CONSTRUCTION SHALL BE REFERRED TO THE PAD FOOTING LAYOUT PLAN N AND DETAILS
- THE DESIGN IS BASED UPON THE GROUND BEARING CAPACITY AT ABOUT 2.0 METRES BELOW EXISTING GROUND LEVEL TO BE 150KN/m
- 3. CONCRETE GRADE 30 SHALL BE USED FOR ALL PAD FOOTING WORKS

# 13. NOTES FOR BAKAU PILING

- 1. WITH A 1/2 TONNE HAMMER AND DROP OF 900mm. THE FINAL SET SHOULD NOT BE MORE THAN 75/10 BLOWS OR THE SET TO BE FINALISED BY THE ENGINEER DURING THE TEST PILING.
- ALL BAKAU PILES SHOULD BE NOT LESS THAN 75mm Ø (ON AVERAGE), ALL PILES CUT-OFF SHALL BE AT THE LOWEST WATER LEVEL. EXACT LEVEL TO BE DETERMINED ON SITE BY THE ENGINEER
- 3. IF PILE REQUIRED TO BE SPLICED TOGETHER, A TUBULAR SPLICE WITH A HEAVY PIPE 90mm Ø x 600mm LONG x 6mm THICK SHOULD BE USED AT LEAST 4 HOLES SHALL BE PROVIDED IN THE PIPE FOR DRIVING 65mm LONG NAILS SPIKE
- 4. ACTUAL SPACING OF BAKAU PILES TO BE DECIDED ON SITE

# 14. NOTES FOR SAFETY OF EXISTING UNDER GROUND SERVICES

1. MAIN CONTRACTOR TO CARRY OUT PILOT TRENCHING (ADEQUATE GROUND INVESTIGATION) BEFORE CARRYING OUT ANY EXCAVATION WORKS FOR DRAINAGE WORKS, PILING WOKS AND OTHER WORKS THAT MAY AFFECT THE BURIED (UNDER GROUND) EXISTING SERVICES/UTILITIES SUCH AS ELECTRICAL CABLES, FIBRE OPTIC CABLES, TELECOM CABLES, WATER PIPES. .THIS IS IMPORTANT TO PREVENT ANY DAMAGE TO SUCH SERVICES /UTILITIES SAFETY THREAT TO ALL STATEHOLDERS.

### 15. NOTES FOR WATERPROOFING WORKS:

- ALL INTERNAL OR EXTERNAL SURFACES OF WATER RETAINING STRUCTURE OR WET AREAS SUCH AS TOILETS, RC ROOF SLABS, RC GUTTERS, M&E ROOMS AND KITCHENS SHALL BE WATERPROOFED WITH APPROVED WATERPROOFING SYSTEM.
  ALL WATERPROOFING WORKS SHALL BE CARRIED OUT BY MANUFACTURER'S APPROVED
- INSTALLER/APPLICATOR AND SHALL BE APPLIED. IN STRICT ACCORDANCE TO THE MANUFACTURER'S APPROVED PROCEDURES OR AS PER ENGINEER'S APPROVAL.
- SUFFICIENT CURING TIME SHALL BE ALLOWED BEFORE INSTALLATION OF ANY PROTECTIVE SCREED OR ARCHITECTURAL FINISHES.
- WATERPROOFING SYSTEMS THAT HAS BEEN APPROVED FOR INSTALLATION SHALL CARRY A 10 YEAR WARRANTY PERIOD BY THE MANUFACTURER OR BY THE MANUFACTURER'S REPRESENTATIVES OR BY THE APPROVED LOCAL DISTRIBUTOR/APPLICATOR.

# 16. GENERAL NOTES FOR ANY STRUCTURAL STEEL WORKS

- MAIN CONTRACTOR SHALL SUBMIT SHOP DRAWINGS FOR ALL STEEL WORKS FOR STRUCTURAL ENGINEER'S APPROVAL BEFORE ORDERING, PURCHASING, FABRICATING AND ERECTING ANY STEEL STRUCTURAL WORKS
- PROPOSED CONNECTION DETAILS TO BE PROVIDED IN THE STRUCTURAL SHOP DRAWINGS FOR STRUCTURAL ENGINEER'S APPROVAL.
- ALL STEEL SECTION MEMBERS SHALL BE SAND BLASTED BEFORE APPLYING ANY APPROVED ANTI-CORROSION COATING SYSTEM.
- 4. ALL WELDING WORKS SHALL BE CARRIED OUT BY QUALIFIED LICENSED WELDERS.

# 17. NOTES FOR TURFING

- ALL TURFS SHALL BE 225MM SQUARE FROM AN APPROVED SOURCE FREE FROM LALLANG AND
- BLACK EARTH OF 50MM THICKNESS SHALL BE SPREAD ON TO THE GROUND WHERE TURFING IS
- SPOT TURFING SHALL BE LAID AT 300MM CENTRES.
- CLOSED TURFING TO BANKS SHALL BE PEGGED IN PLACE WITH 25MM DIAMETER PEGS 225MM LONG. ALL TURFING SHALL BE WATERED UNTIL SATISFACTORILY ESTABLISHED AND ALL TURFING THAT HAS BECOME DEFECTIVE WITHIN SIX MONTHS SHALL BE REPLACED AT THE CONTRACTOR'S EXPENSE
- DURING THE PERIOD OF THE WORKS AND MAINTENANCE, THE CONTRACTOR SHALL KEEP ALL TURFED AREAS WATERED, MOWN OR CUT AND CLEARED OF GRASS CUTTING TO THE SATISFACTION OF THE ENGINEER. THE FIRST CUT SHALL BE MADE WHEN THE GRASS IS 100MM HIGH, FOLLOWED BY REGULAR CUTTING SO THAT THE VEGETATION AT NO TIME EXCEEDS 150MM IN HEIGHT.

### 18. DRAWING NOTE:

ALL STRUCTURAL DRAWING ARE DRAWN TO APPROXIMATE SCALE. ANY DISCREPANCY IN STRUCTURAL DRAWING DIMENSIONS, EXACT DIMENSION SHALL BE REFERRED TO STRUCTURAL ENGINEER

# 19. GENERAL NOTES FOR FLOOR HARDENER REQUIREMENTS:

ALL CONCRETE SLAB SURFACES WHICH ARE NOT COVERED WITH HEAVY DUTY DECORATIVE TILES AND TO BE USED AS CAR PARKS OR ACCESS ROADS (FOR SELECTED AREAS) SHALL BE APPLIED WITH SUITABLE FLOOR HARDENERS SYSTEM (TO INCLUDE POWER FLOAT TROWELLING IF APPLICABLE)

# 20. GENERAL NOTES FOR BRICKWALL WORKS:

- ALL BRICKS TO BE USED SHALL BE REGULAR IN SIZE AND APPROVED BY ABCI REINFORCED CONCRETE STIFFENERS (100x100 WITH APPROPRIATE REINFORCEMENTS)SHALL BE PROVIDED AT EVERY INTERVAL OF 3.5m OF BRICK WORK LENGTH

# 21. NOTES FOR WORKPLACE SAFETY, HEALTH AND ENVIRONMENT COMPLIANCE & INSURANCES & TEMPORARY WORKS:

- MAIN CONTRACTOR SHALL ENSURE TO COMPLY FULLY WITH ALL PREVAILING RULES, REGULATIONS AND LAWS OF NEGARA BRUNEI DARUSSALAM ON WORKPLACE SAFETY, HEALTH AND ENVIRONMENTAL ASPECTS THROUGHOUT THE DURATION OF THE CONSTRUCTION PERIOD AND DEFECTS LIABILITY PERIOD
  2. MAIN CONTRACTOR SHALL ENSURE THAT ALL APPLICABLE INSURANCES ARE VALID THROUGHOUT THE
- CONSTRUCTION PERIOD AND DEFECTS LIABILITY PERIOD SUCH AS CONTRACTOR'S ALL RISK INSURANCE OR OTHERS SUCH AS WORKMEN COMPENSATION INSURANCE POLICY, PUBLIC LIABILITY INSURANCE POLICY AND FIRE INSURANCE POLICY(WHICHEVER IS APPLICABLE AS PER SUPERINTENDING OFFICERS
- 3. MAIN CONTRACTOR SHALL EMPLOY INDEPENDENT CONSULTANT TO CARRYOUT DESIGN WORKS FOR ALL TEMPORARY WORKS AND THAT SUCH TEMPORARY WORKS DESIGN REQUIREMENT ARE FULLY COMPLIED

# 22. NOTES FOR ROOF TRUSSES:

- ROOF TRUSSES SHALL BE LIGHTWEIGHT PROPRIETARY SYSTEM SUCH AS LYSAGTH SMART TRUSS SYSTEM OR APPROVED TECHNICAL EQUIVALENT SHALL BE DESIGNED BY MANUFACTURER COMPAN
- 2. THE INSTALLATION WORKS SHALL BE CARRIED OUT BY MANUFACTURER'S APPROVED INSTALLER





SERI BUMI CONSULTANT


Ť	l
MPANG M	l
	ı


				DESIGNED BY	THAN ZAW TUN	
				DRAWN BY	SAI	
				<b>-</b>	MD VIINIIO	<del>)</del>
				CHECKED BY	MD. YUNUS	
NO.	AMENDMENTS	BY	DATE	APPROVED BY		DATE 14/09/20



N.T.S


GENERAL NOTES POJECT PROPOSED NEW 1 UNIT STANDARD DESIGN OF FARM LABOUR QUARTERS, BRUNEI DARUSSALAM (FOR 5 PERSONS) -OPTION 2 SBC/Q366/AFLQ/5P/ST/G - 10

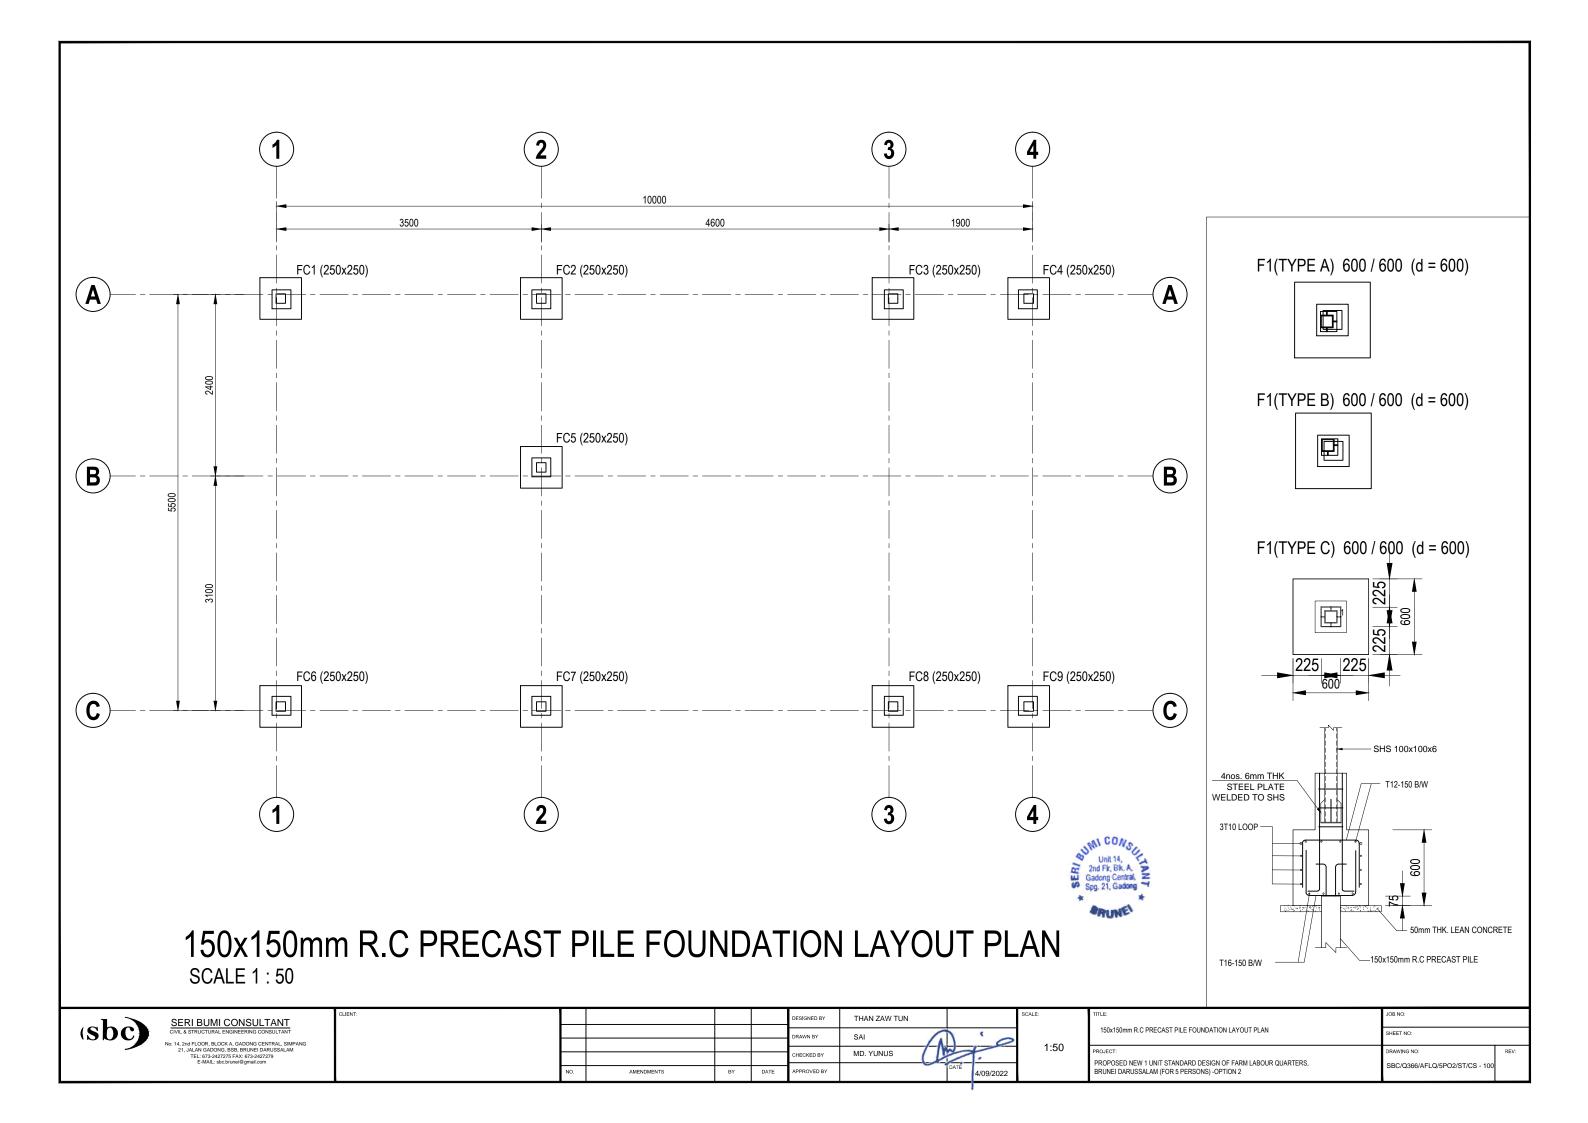


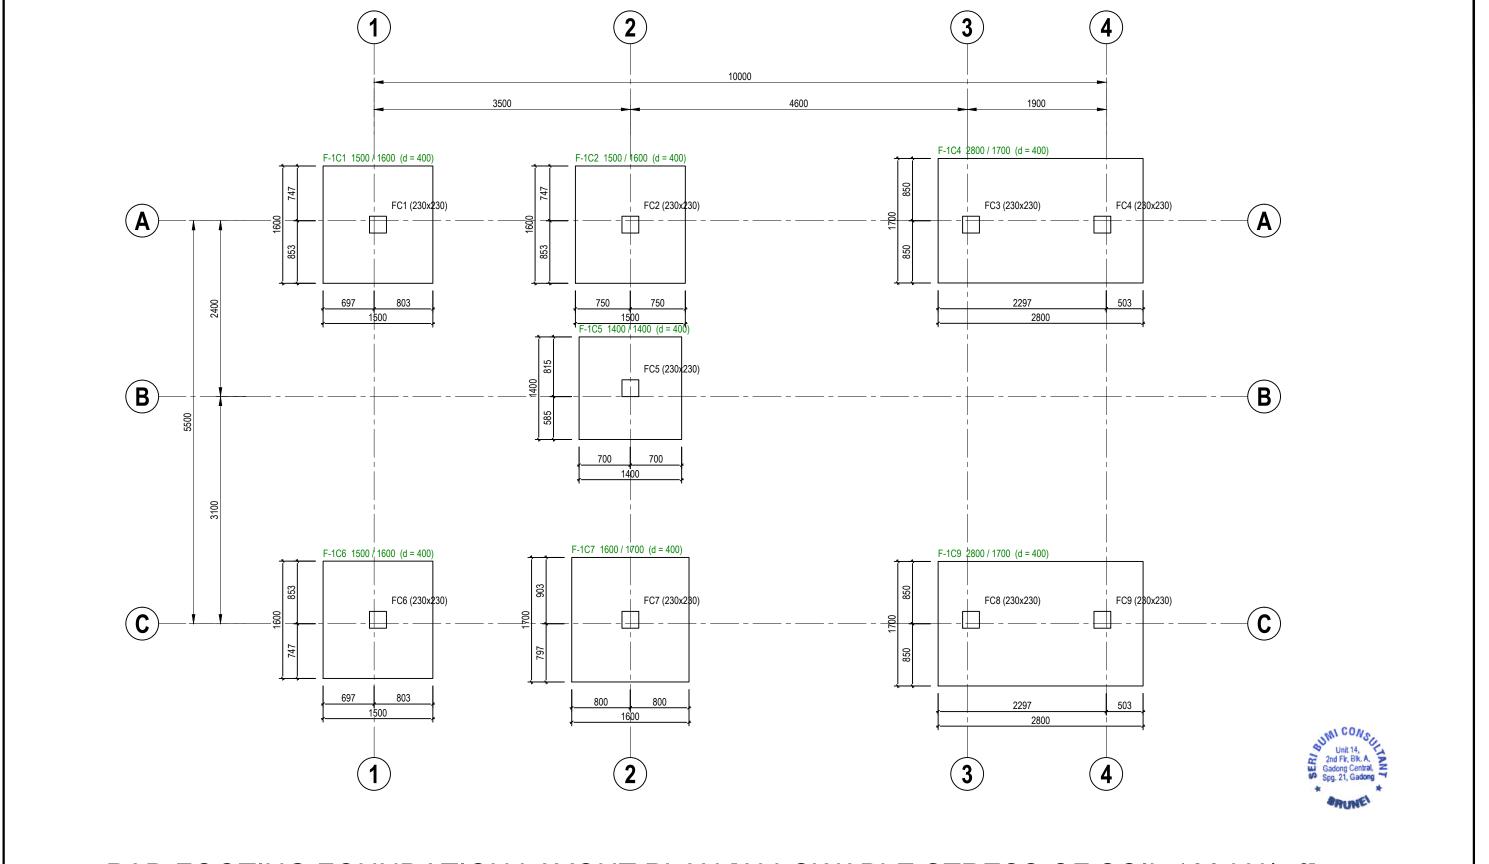


# PAD FOOTING FOUNDATION LAYOUT PLAN [ALLOWABLE STRESS OF SOIL 100 kN/m²]

SCALE 1:50

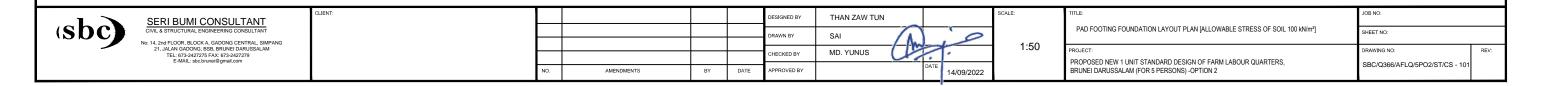

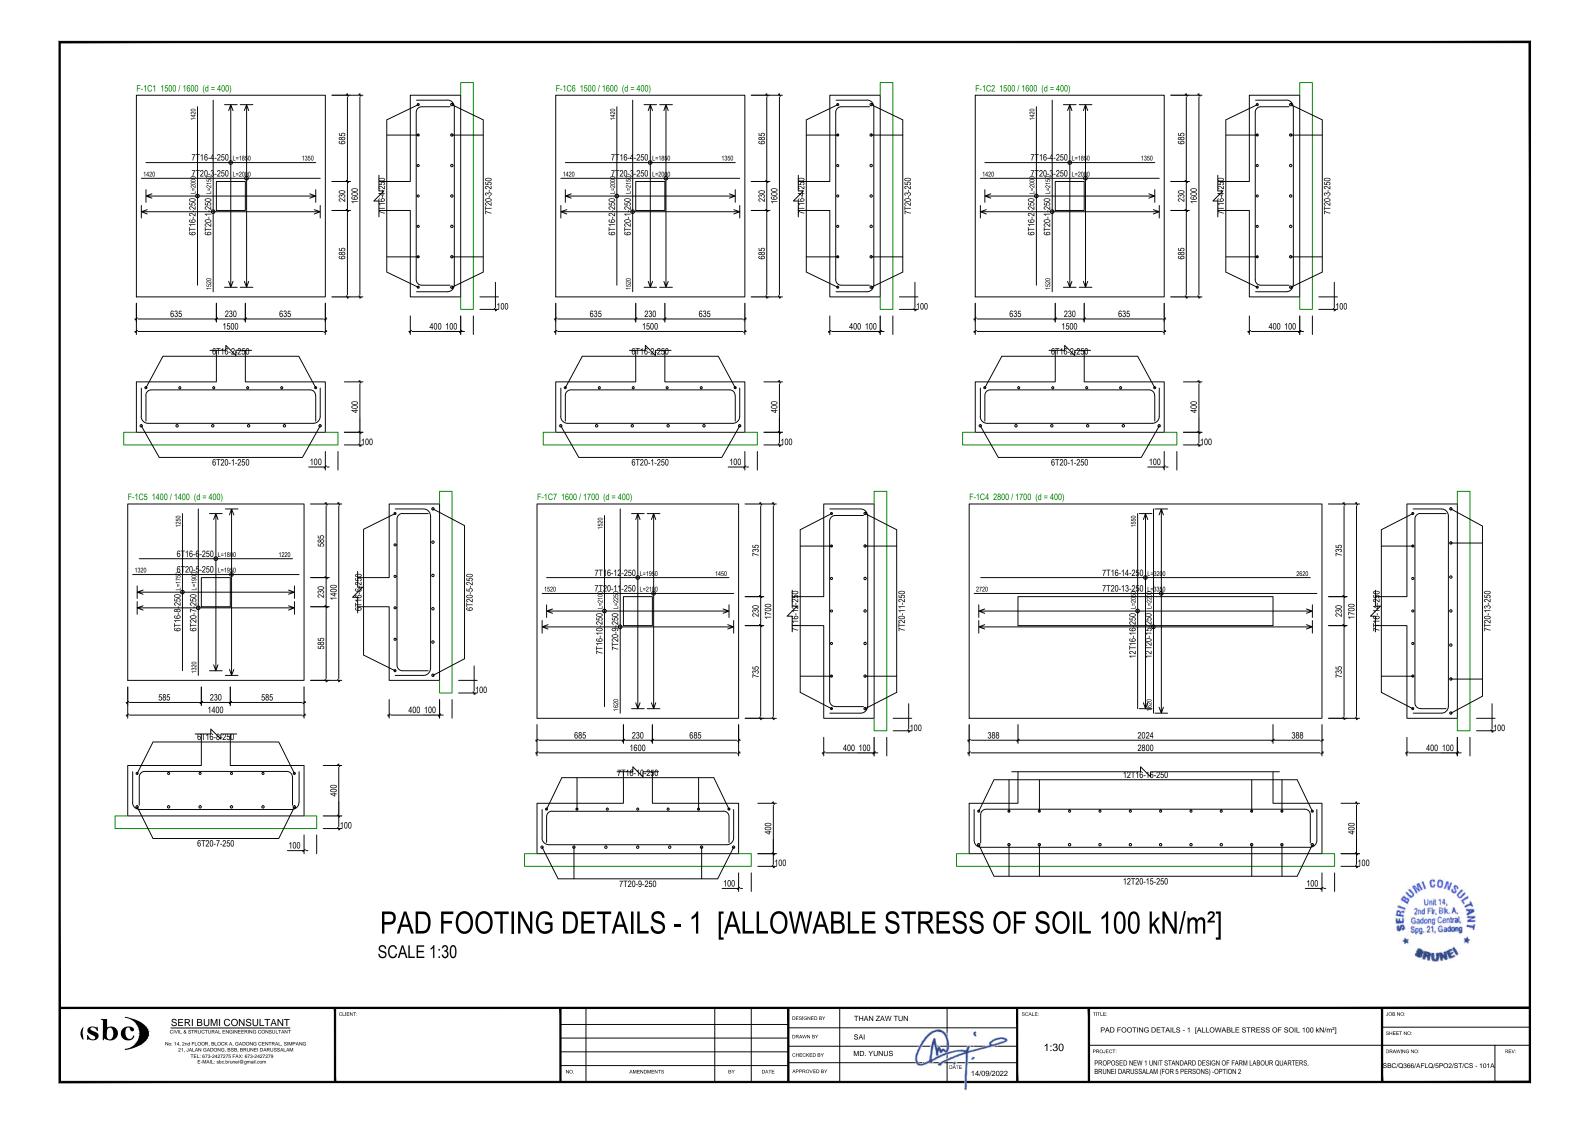

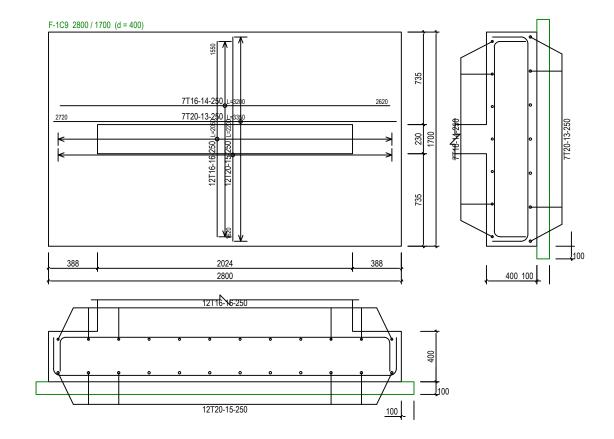

# PAD FOOTING DETAILS - 2 [ALLOWABLE STRESS OF SOIL 100 kN/m²] SCALE 1:30





1.	SERI BUMI CONSULTANT	CLIENT:					DESIGNED BY	THAN ZAW TUN			SCALE:	TITLE:	JOB NO:	
(SDC)	CIVIL & STRUCTURAL ENGINEERING CONSULTANT  No: 14. 2nd FLOOR, BLOCK A, GADONG CENTRAL, SIMPANG						DRAWN BY	SAI	1	'0	4.00	PAD FOOTING DETAILS - 2 [ALLOWABLE STRESS OF SOIL 100 kN/m²]	SHEET NO:	
1	21, JALAN GADONG, BSB, BRUNEI DARUSSALAM TEL: 673-2427275 FAX: 673-2427279 E-MAIL: sbc.brunei@gmail.com						CHECKED BY	MD. YUNUS			1:30	PROPOSED VENA UNIT CTANDARD DEGICAL OF FARMA ARCHIT GUARTERS	DRAWING NO:	REV:
			NO.	AMENDMENTS	BY	DATE	APPROVED BY		DATE	14/09/2022		BRUNEI DARUSSALAM (FOR 5 PERSONS) -OPTION 2	SBC/Q366/AFLQ/5PO2/ST/CS - 101B	3



# PAD FOOTING FOUNDATION LAYOUT PLAN [ALLOWABLE STRESS OF SOIL 150 kN/m<sup>2</sup>]

SCALE 1:50

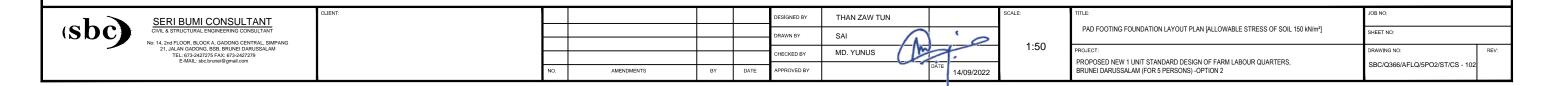

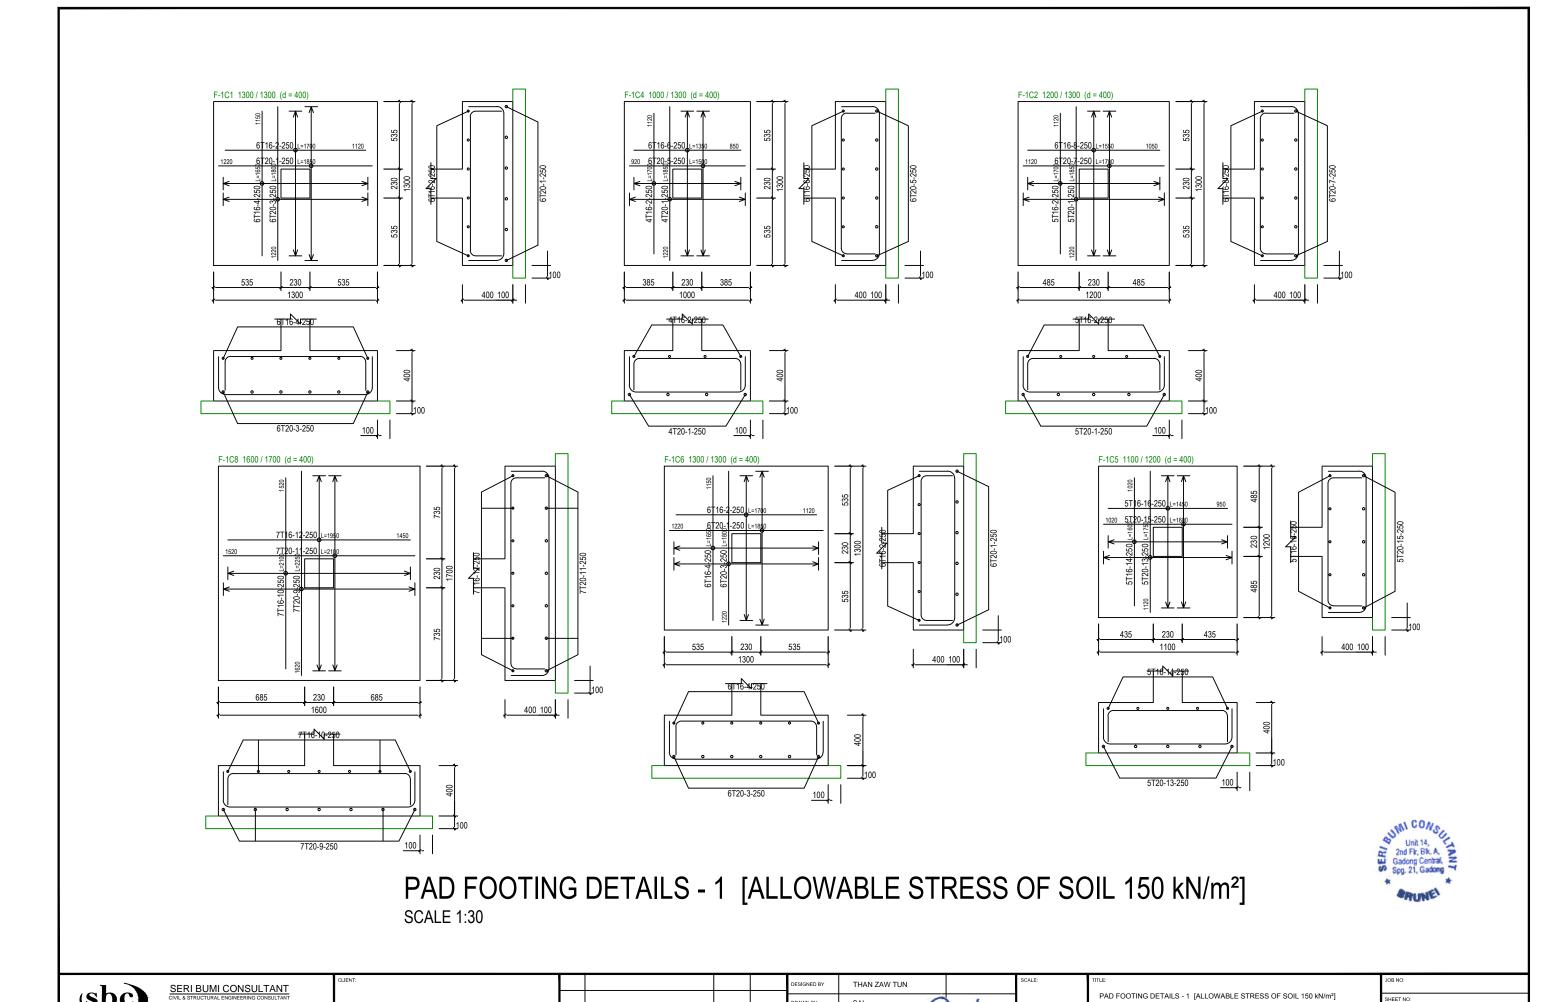

PAD FOOTING DETAILS - 1 [ALLOWABLE STRESS OF SOIL 150 kN/m²]

BC/Q366/AFLQ/5PO2/ST/CS - 102


PROPOSED NEW 1 UNIT STANDARD DESIGN OF FARM LABOUR QUARTERS, BRUNEI DARUSSALAM (FOR 5 PERSONS) - OPTION 2


1:30


14/09/2022

MD. YUNUS

(sbc)

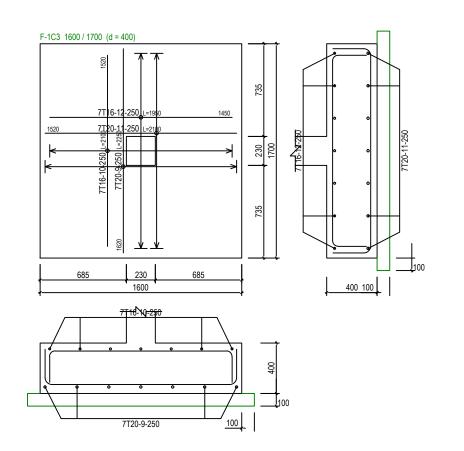

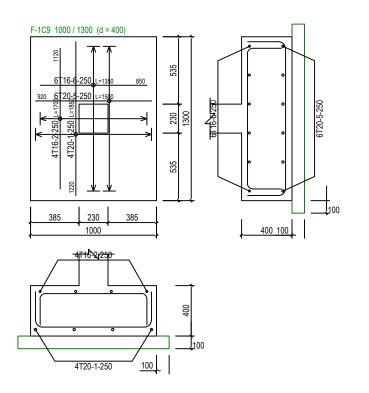


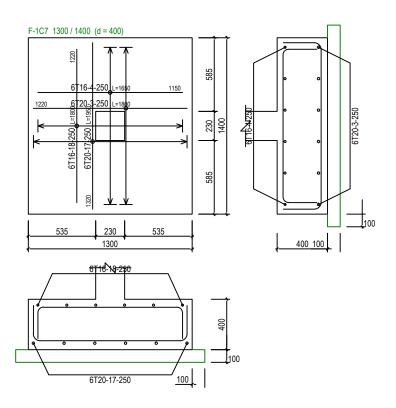


# PAD FOOTING DETAILS - 2 [ALLOWABLE STRESS OF SOIL 150 kN/m²] SCALE 1:30




SERI BUMI CONSULTANT			DESIGNED BY	THAN ZAW TUN		SCALE:	TITLE:	JOB NO:	
(SDC) CIVIL & STRUCTURAL ENGINEERING CONSULTANT  NO. 14. 2nd FLOOR BLOCK A GADONG CENTRAL SIMPANG			DRAWN BY	SAI	10	4.00	PAD FOOTING DETAILS - 2 [ALLOWABLE STRESS OF SOIL 150 kN/m²]	SHEET NO:	
21, JALAN GADONG, BSB, BRUNEI DARUSSALAM TEL: 673-24/27/275 FAX: 673-24/27/29 E-MAL: Sbotunseil@gmail.com			CHECKED BY	MD. YUNUS	7.	1:30	PROJECT: PROPOSED NEW 1 UNIT STANDARD DESIGN OF FARM LABOUR QUARTERS,	DRAWING NO:	REV:
	NO. AMENDMENTS	BY DATE	APPROVED BY		14/09/2022		BRUNEI DARUSSALAM (FOR 5 PERSONS) -OPTION 2	SBC/Q366/AFLQ/5PO2/ST/CS - 102B	

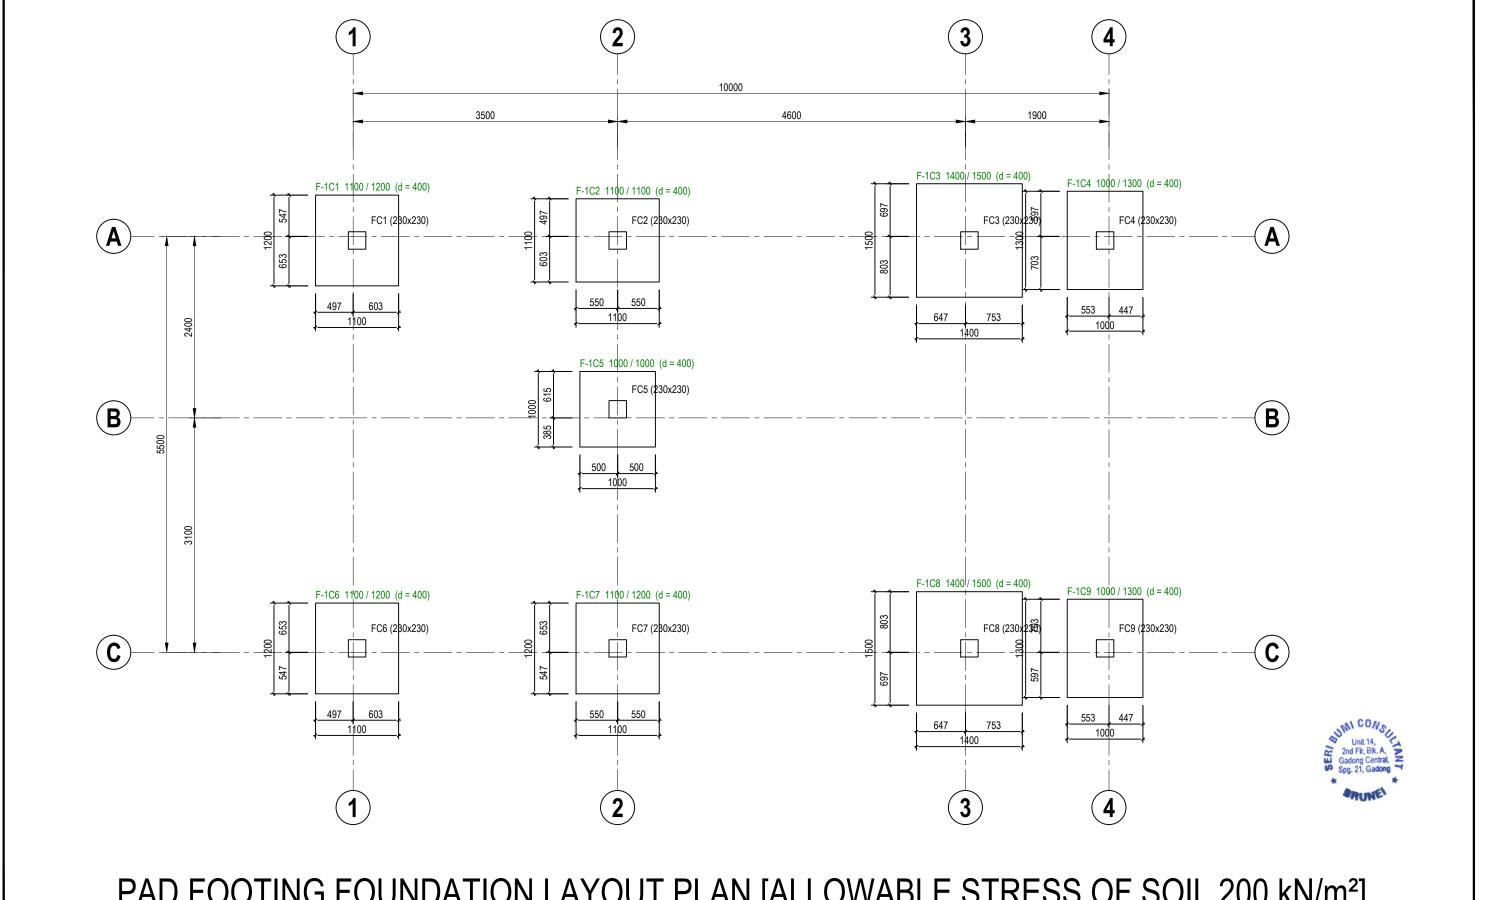


# PAD FOOTING FOUNDATION LAYOUT PLAN [ALLOWABLE STRESS OF SOIL 200 kN/m²] SCALE 1:50

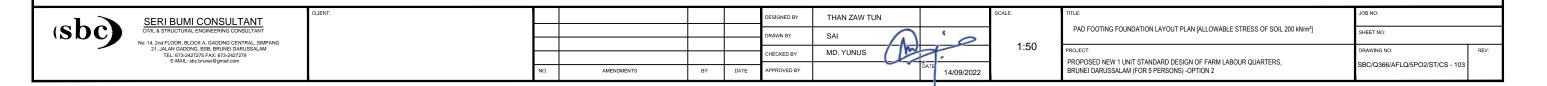


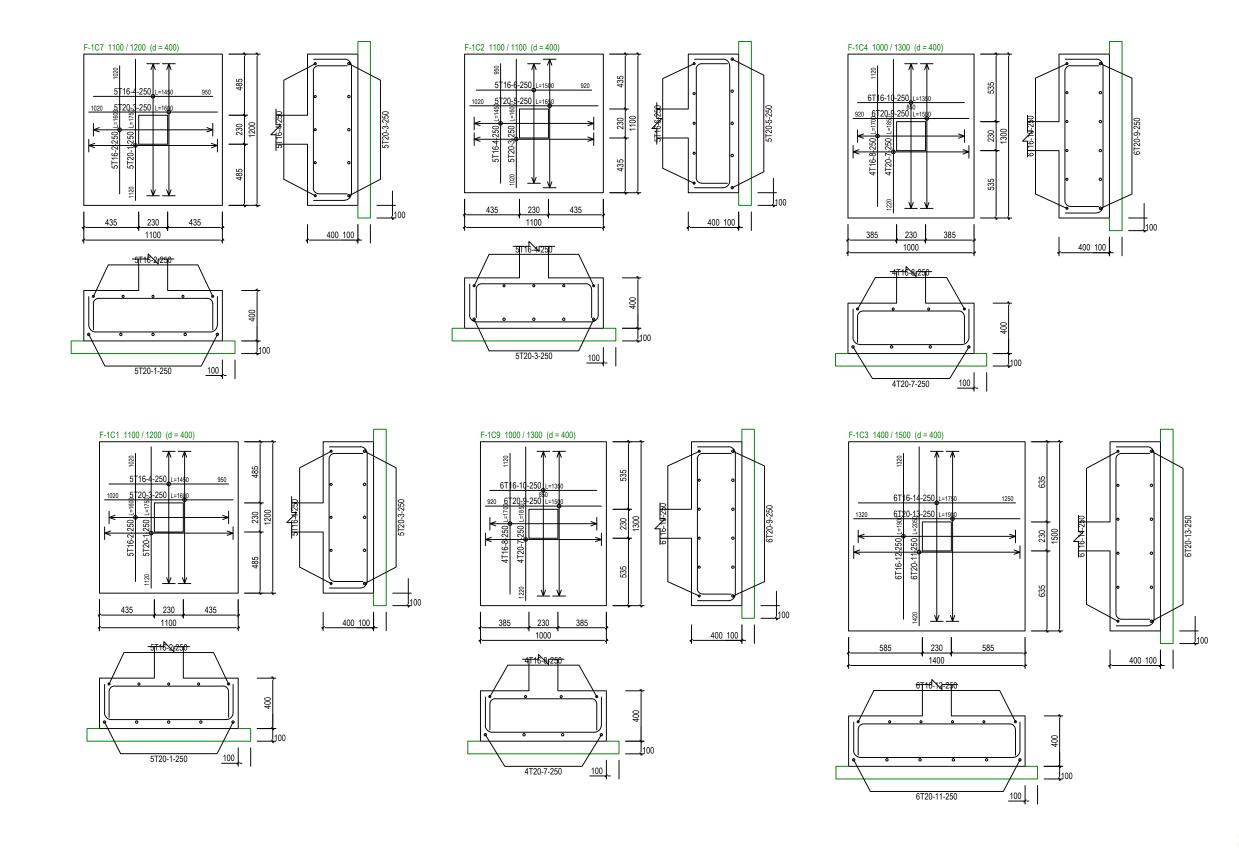



# PAD FOOTING DETAILS - 1 [ALLOWABLE STRESS OF SOIL 200 kN/m²] SCALE 1:30



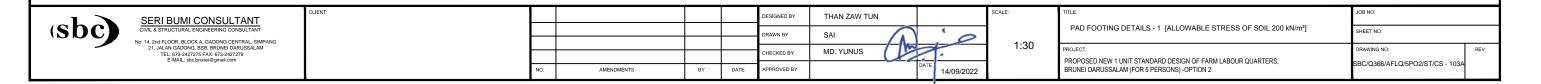

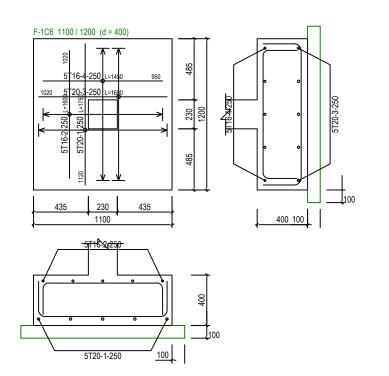


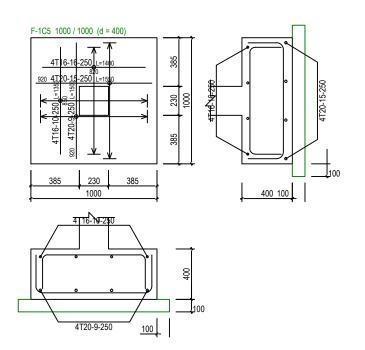


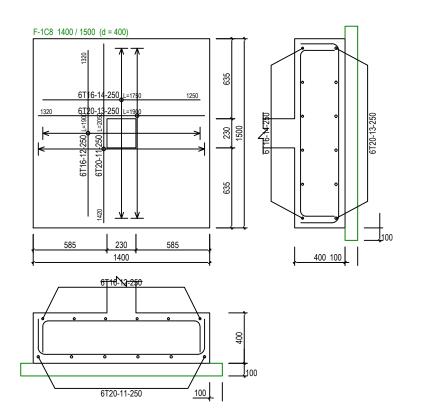


# PAD FOOTING DETAILS - 2 [ALLOWABLE STRESS OF SOIL 200 kN/m²] SCALE 1:30



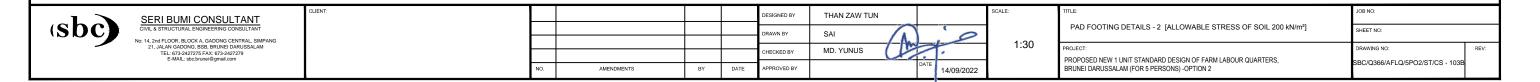

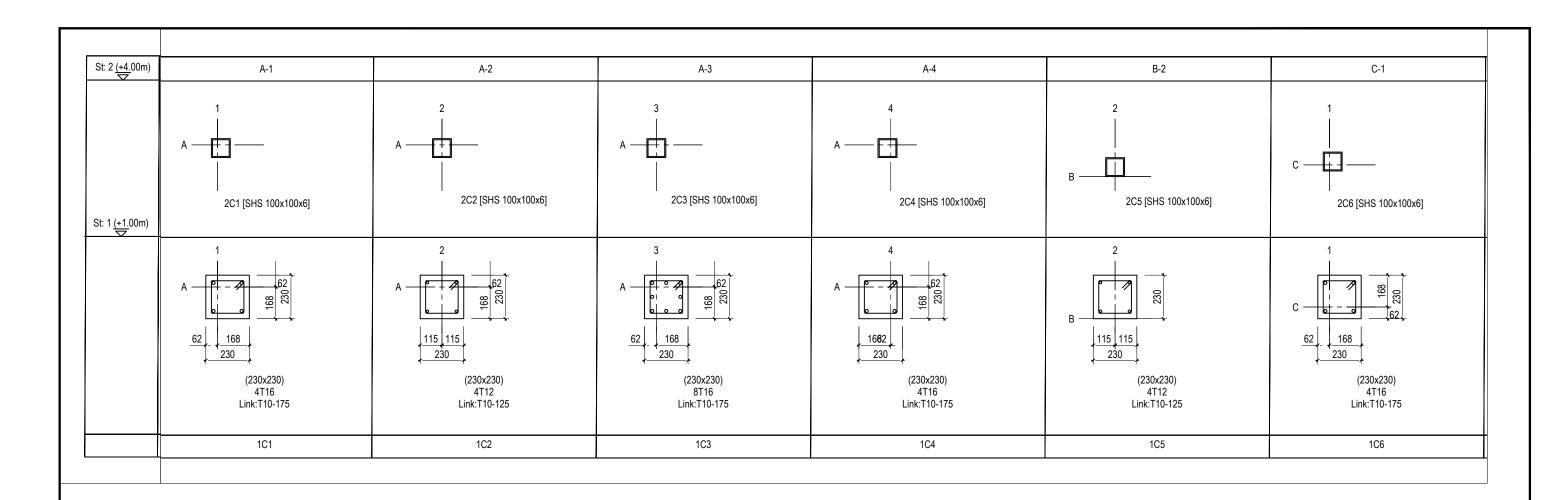

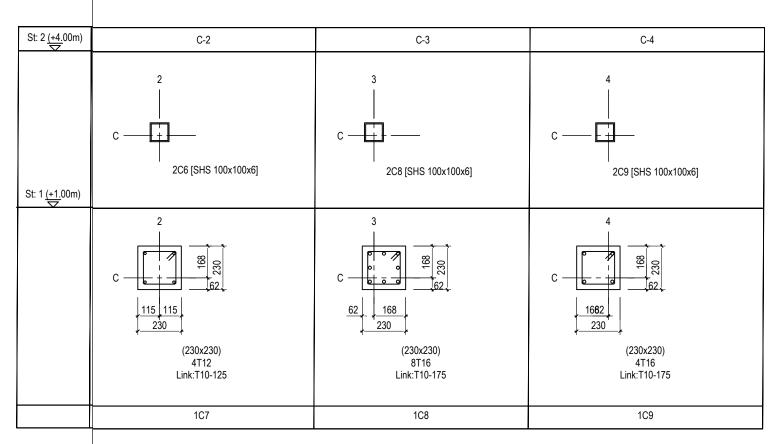



(sbc)

SERI BUMI CONSULTANT
CIVIL & STRUCTURAL ENGINEERING CONSULTANT
No: 14, 2nd FLOOR, BLOCK A, GADONG CENTRAL, SIMPANG
21, JALAN ADDONG, BSB RIUNEI DARRUSSALAM
TEL 673-242775 FAX: 673-242771
EMAIL: stc. bruned dimmai com.

DESIGNED BY THAN ZAW TUN

DRAWN BY SAI

CHECKED BY MD. YUNUS

DATE APPROVED BY

DATE 14/09/2022

N.T.S

TITLE:

COLUMN SCHEDULE


SHEET NO:

PROJECT:

PROPOSED NEW 1 UNIT STANDARD DESIGN OF FARM LABOUR QUARTERS,
BRUNEI DARRUSSALAM (FOR 5 PERSONS) - OPTION 2

DRAWING NO:

SBC/Q366/AFLQ/5PO2/ST/CS - 104

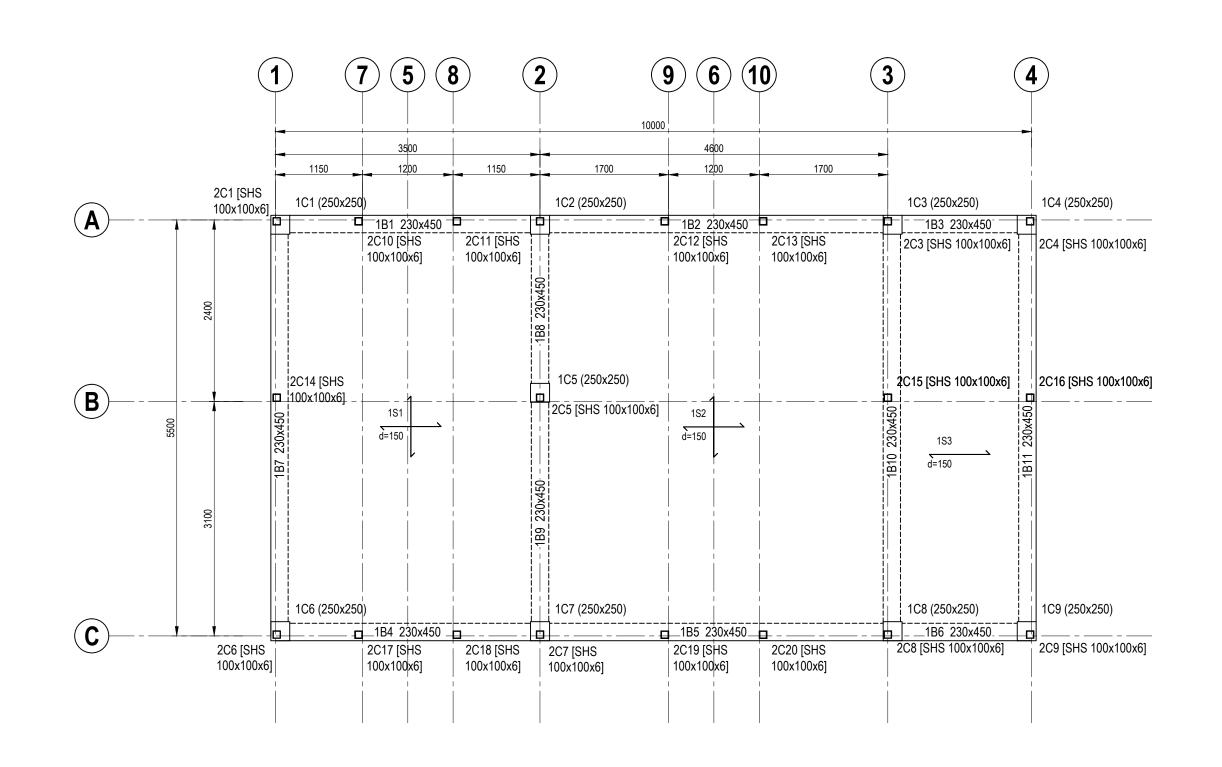



# GROUND FLOOR BEAM LAYOUT PLAN

SCALE 1:50




-1->	SERI BUMI CONSULTANT	CLIENT:				DESIGNED BY	THAN ZAW TUN		SCALE:	TITLE:	JOB NO:
(Sbc)	CIVIL & STRUCTURAL ENGINEERING CONSULTANT  No: 14, 2nd FLOOR, BLOCK A, GADONG CENTRAL, SIMPANG					DRAWN BY	SAI	,	4.50	GROUND FLOOR BEAM LAYOUT PLAN	SHEET NO:
	21, JALAN GADONG, BSB, BRUNEI DARUSSALAM TEL: 673-2427275 FAX: 673-2427279 E-MALL: sbc.brunei@gmail.com					CHECKED BY	MD. YUNUS	· ·	1:50	PROJECT: PROPOSED NEW 1 UNIT STANDARD DESIGN OF FARM LABOUR QUARTERS,	DRAWING NO: REV:
			NO.	AMENDMENTS	BY DA	E APPROVED BY	DATE	14/09/2022		BRUNEI DARUSSALAM (FOR 5 PERSONS) -OPTION 2	SBC/Q366/AFLQ/5PO2/ST/CS - 200

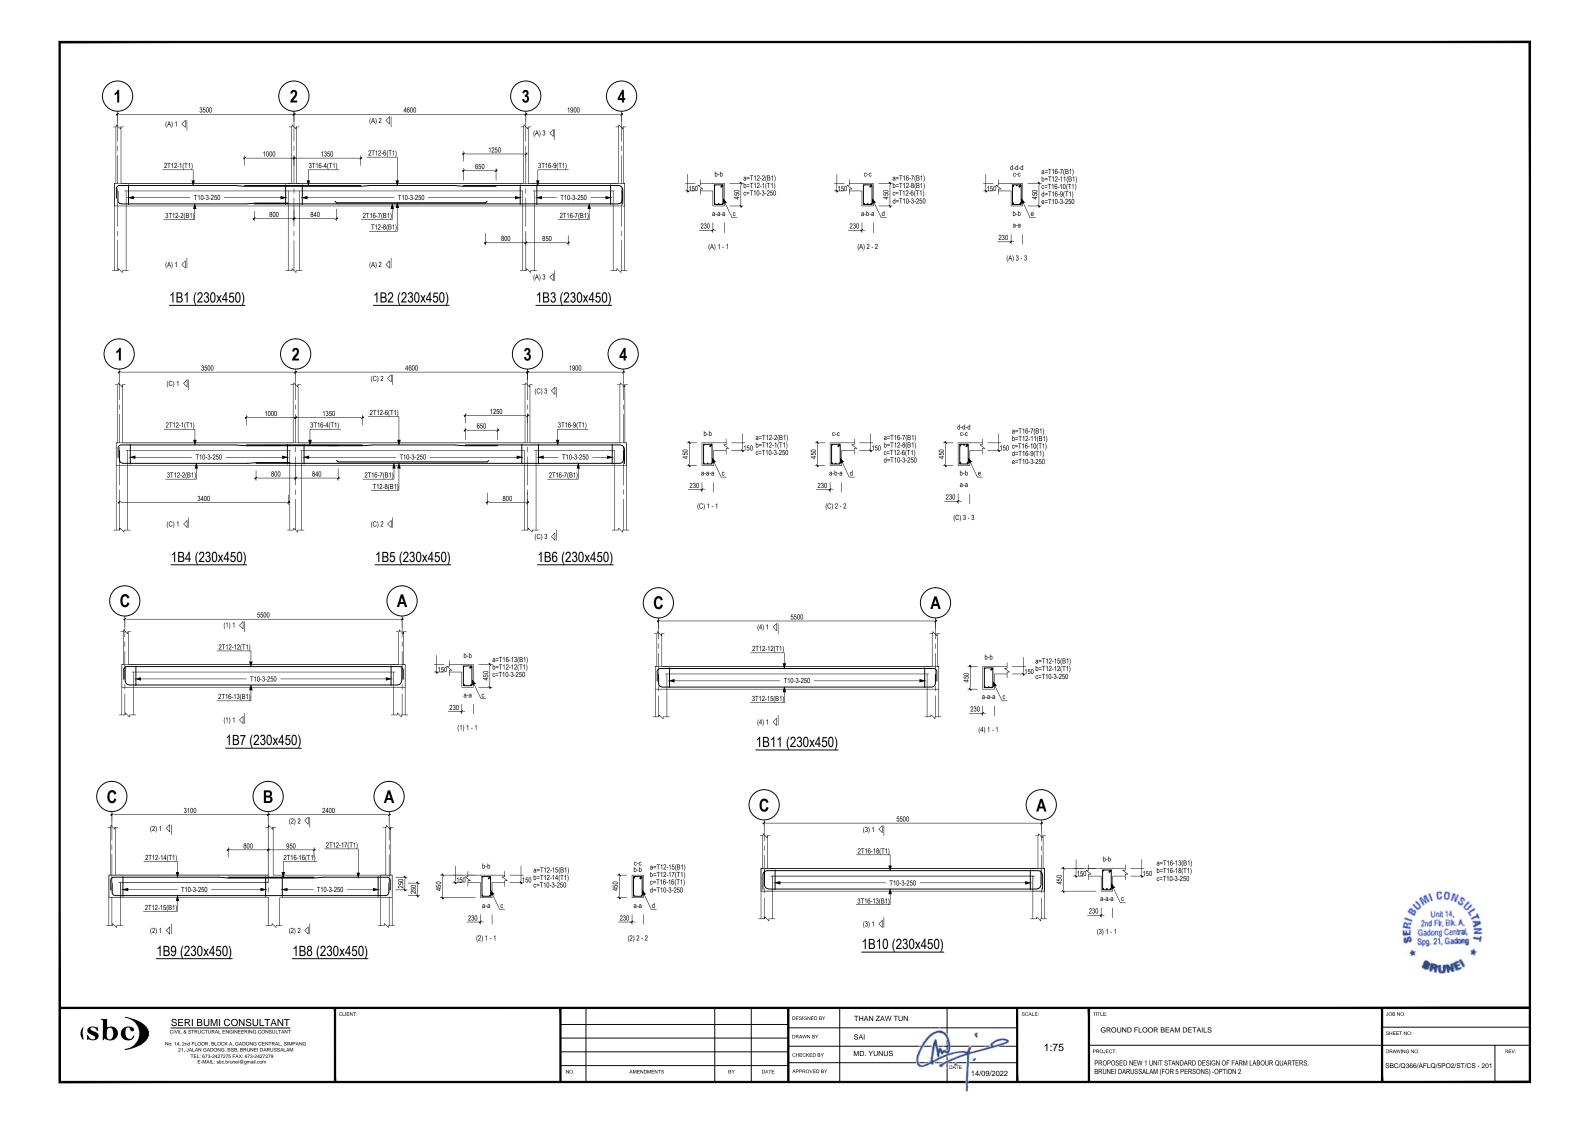

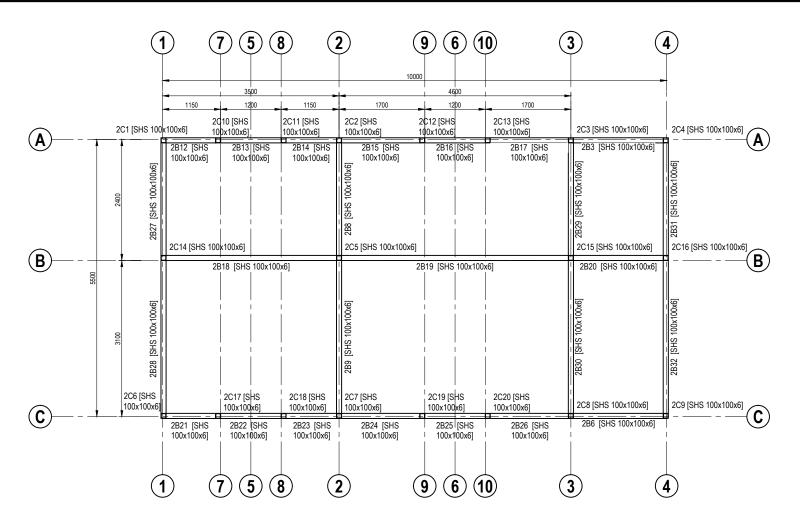

# **ROOF BEAM LAYOUT PLAN**

SCALE 1:75

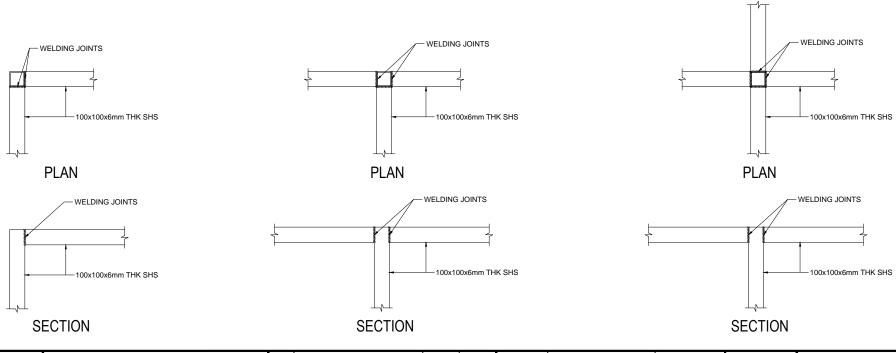







				DESIGNED BY	THAN ZAW TUN			SCAL
				DRAWN BY	SAI	1	0	l
								ı
				CHECKED BY	MD. YUNUS		×	ı
NO.	AMENDMENTS	BY	DATE	APPROVED BY		DATE	14/09/2022	
							1	

TITLE:	JOB NO:	
ROOF BEAM LAYOUT PLAN	SHEET NO:	
PROJECT:	DRAWING NO:	REV:
PROPOSED NEW 1 UNIT STANDARD DESIGN OF FARM LABOUR QUARTERS, BRUNEI DARUSSALAM (FOR 5 PERSONS) -OPTION 2	SBC/Q366/AFLQ/5PO2/ST/CS - 300	

1:50

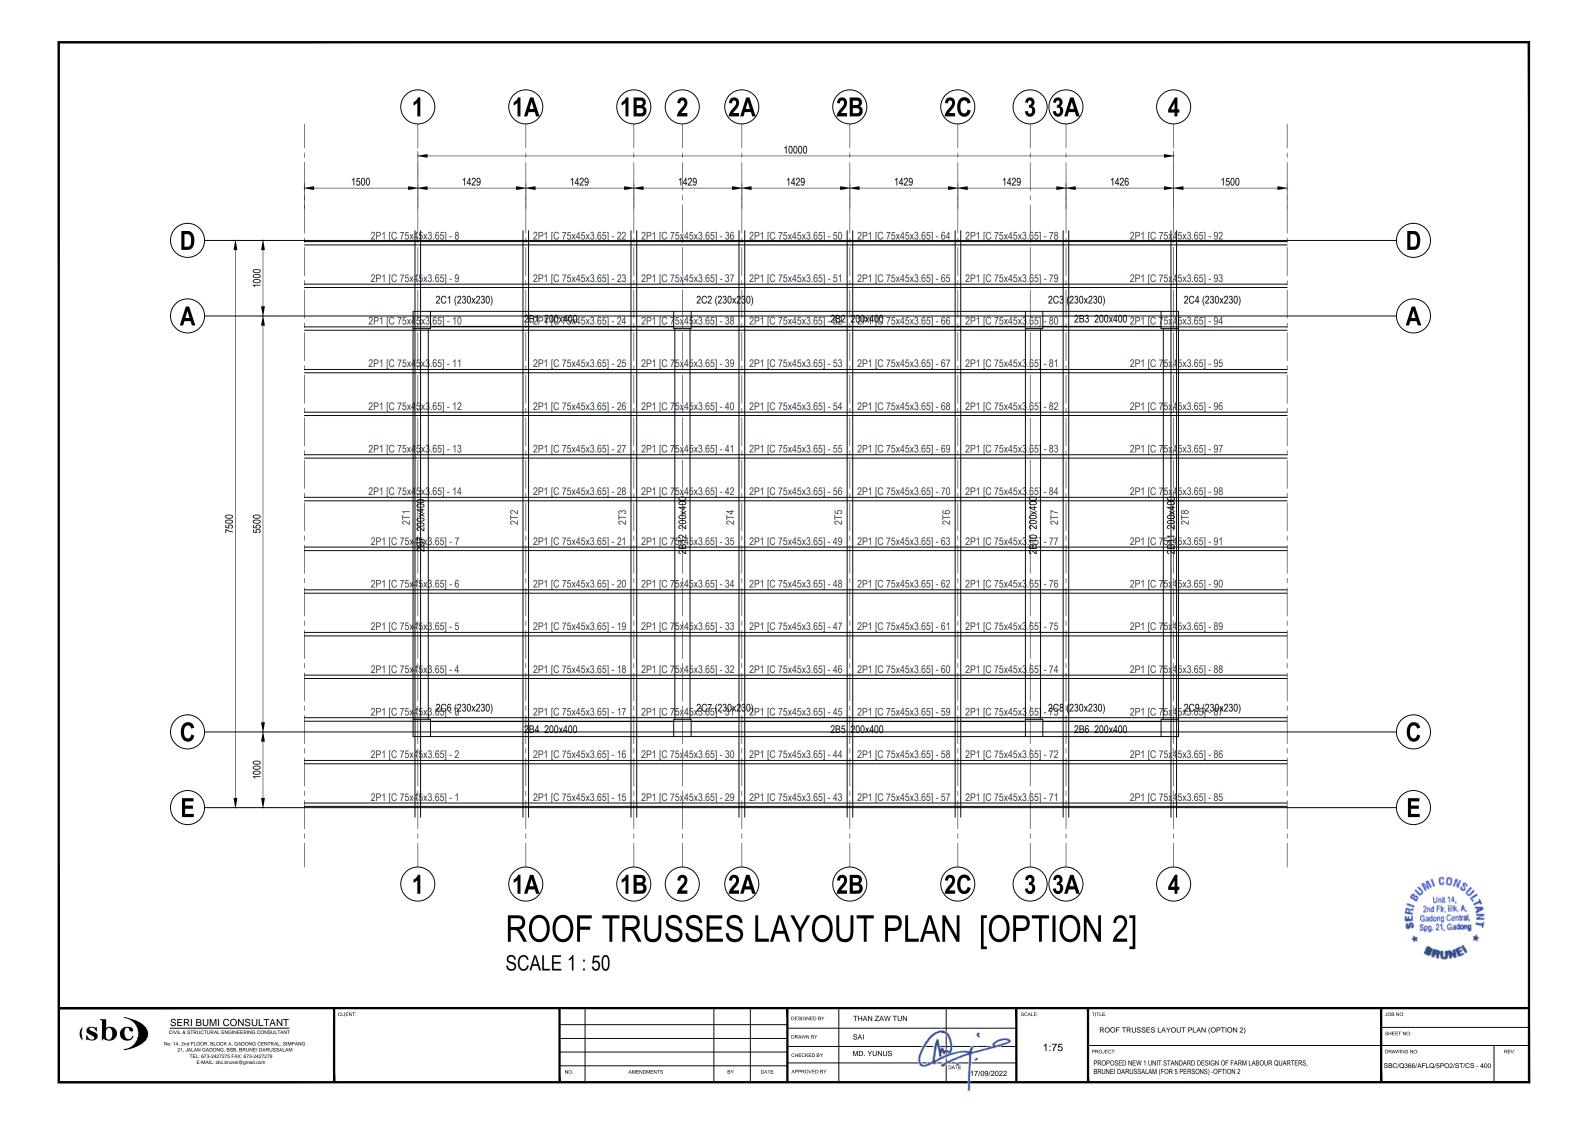


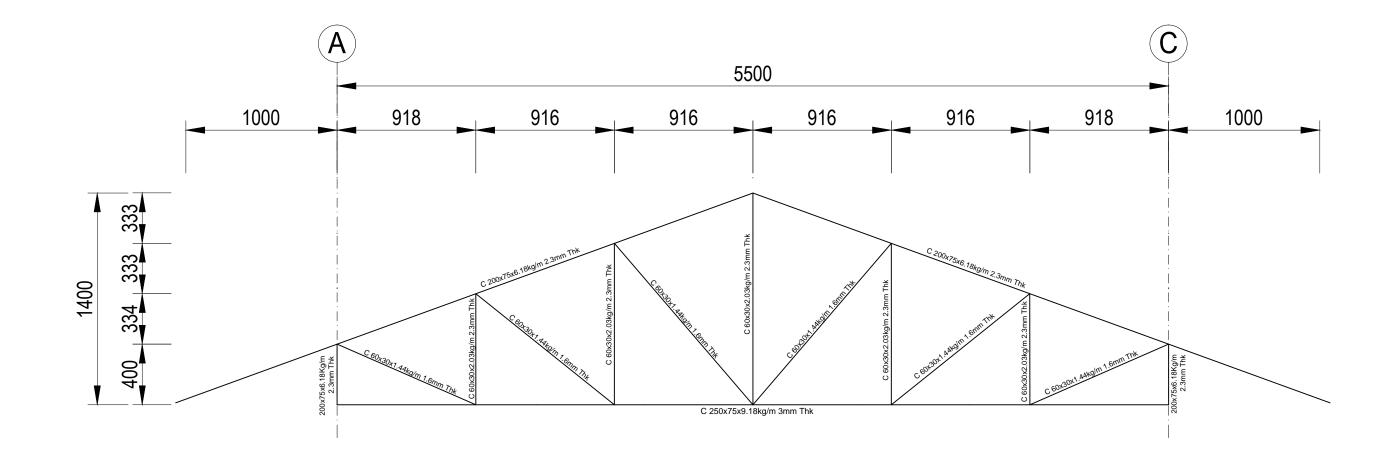



# ROOF TRUSS SECTION (FOR ROOF TRUSS TO STEEL BEAM CONNECTION)



SERI BUMI CONSULTANT				DESIGNED BY	THAN ZAW TUN		SCALE:	TITLE:	JOB NO:	
(SDC) CIVIL & STRUCTURAL ENGINEERING CONSULTANT  No. 14, 2nd FLOOR, BLOCK A, GADONG CENTRAL, SIMPANG	F			DRAWN BY	SAI	.0		ROOF TRUSSES SECTION (FOR ROOF TRUSS TO REINFORCE CONCRETE BEAM CONNECTION)	SHEET NO:	
21, JALAN GADONG, BSB, BRUNEI DARUSSALAM TEL: 673-2427275 FAX: 673-2427279 E-MAIL: sbc.brunei@gmail.com	ŀ			CHECKED BY	MD. YUNUS		1:20	PROPOSED VEW AUGUS OTANDARD DEGICAL OF FARM AROUND OUR PTERS	DRAWING NO:	REV:
		NO. AMENDMENTS	BY DATE	APPROVED BY	DATE	20/09/2022		BRUNEI DARUSSALAM (FOR 5 PERSONS) - OPTION 2	SBC/Q366/AFLQ/5PO2/ST/CS - 401	1

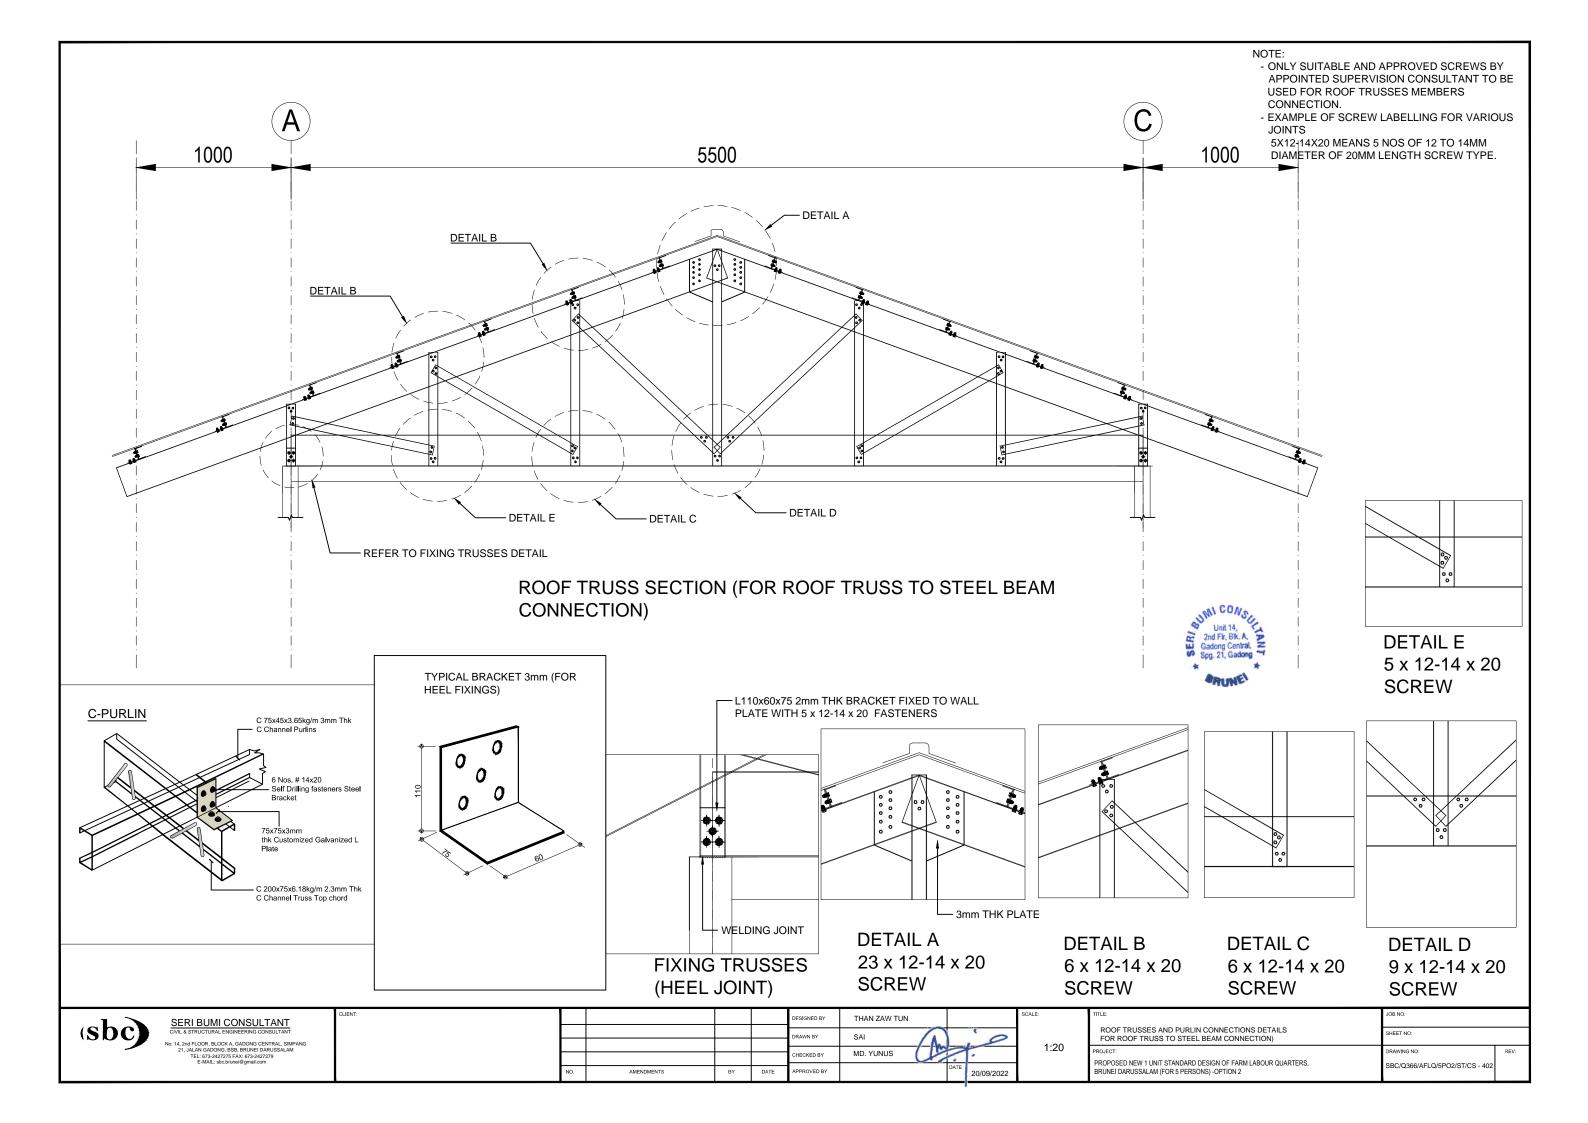

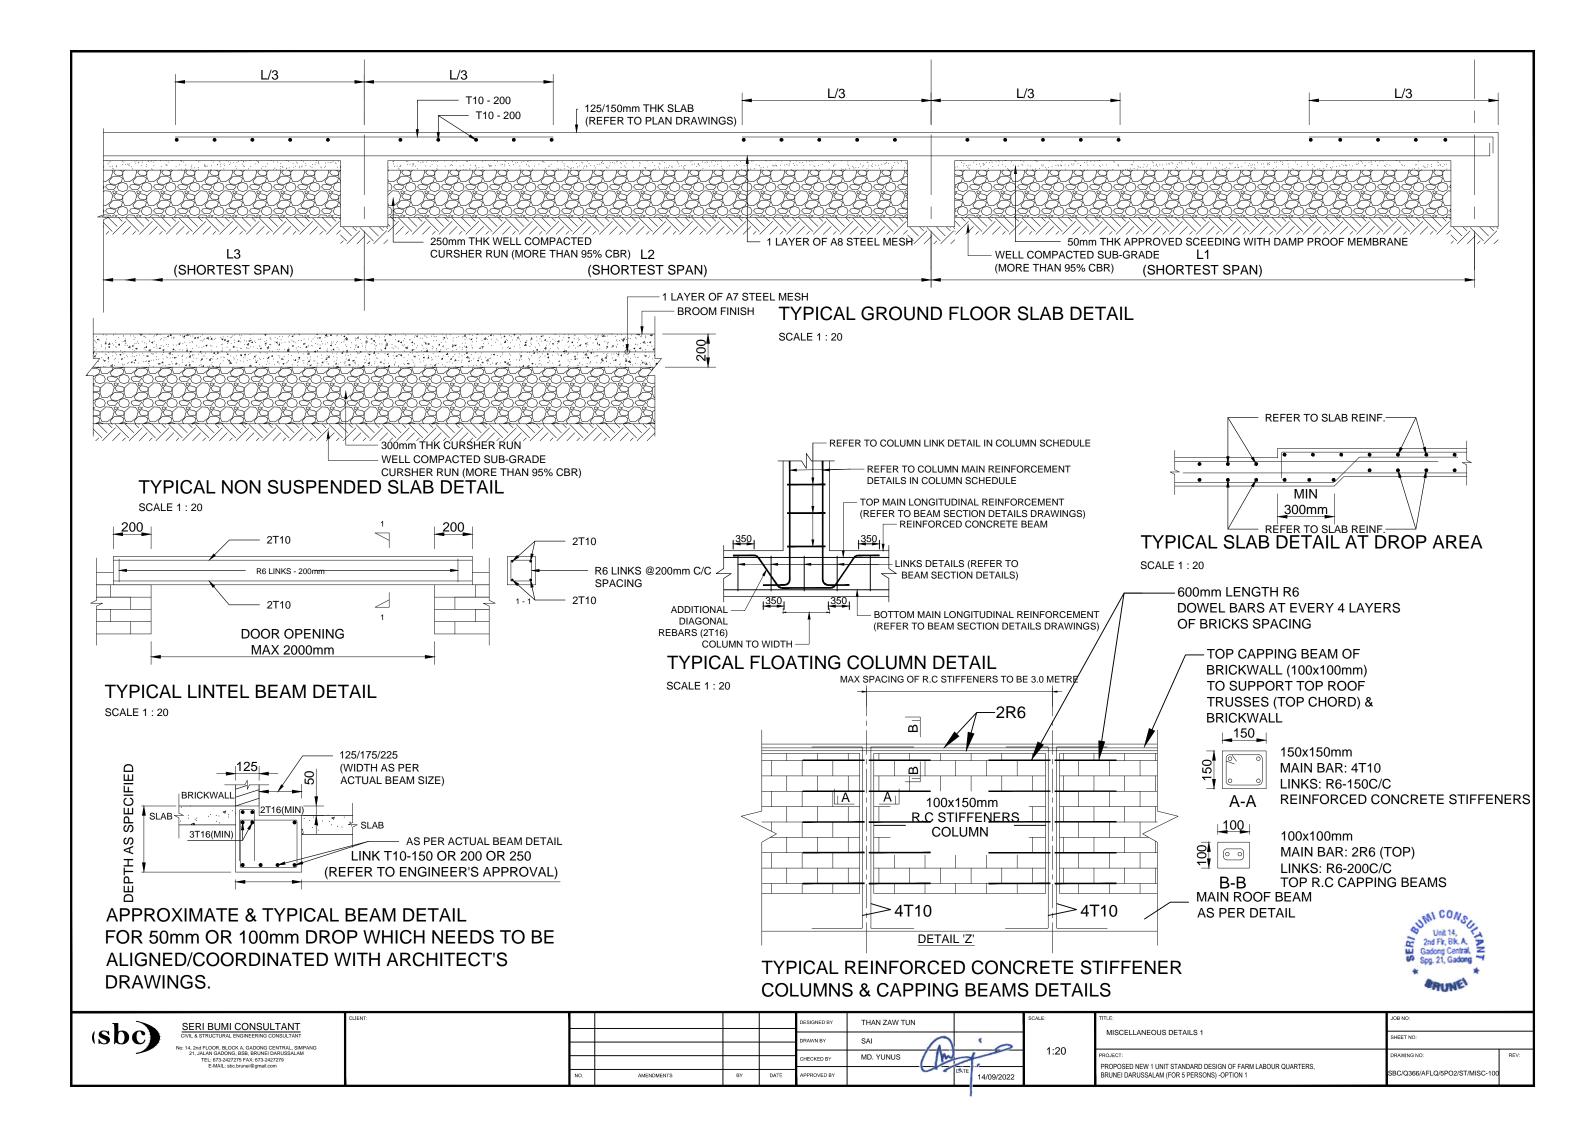

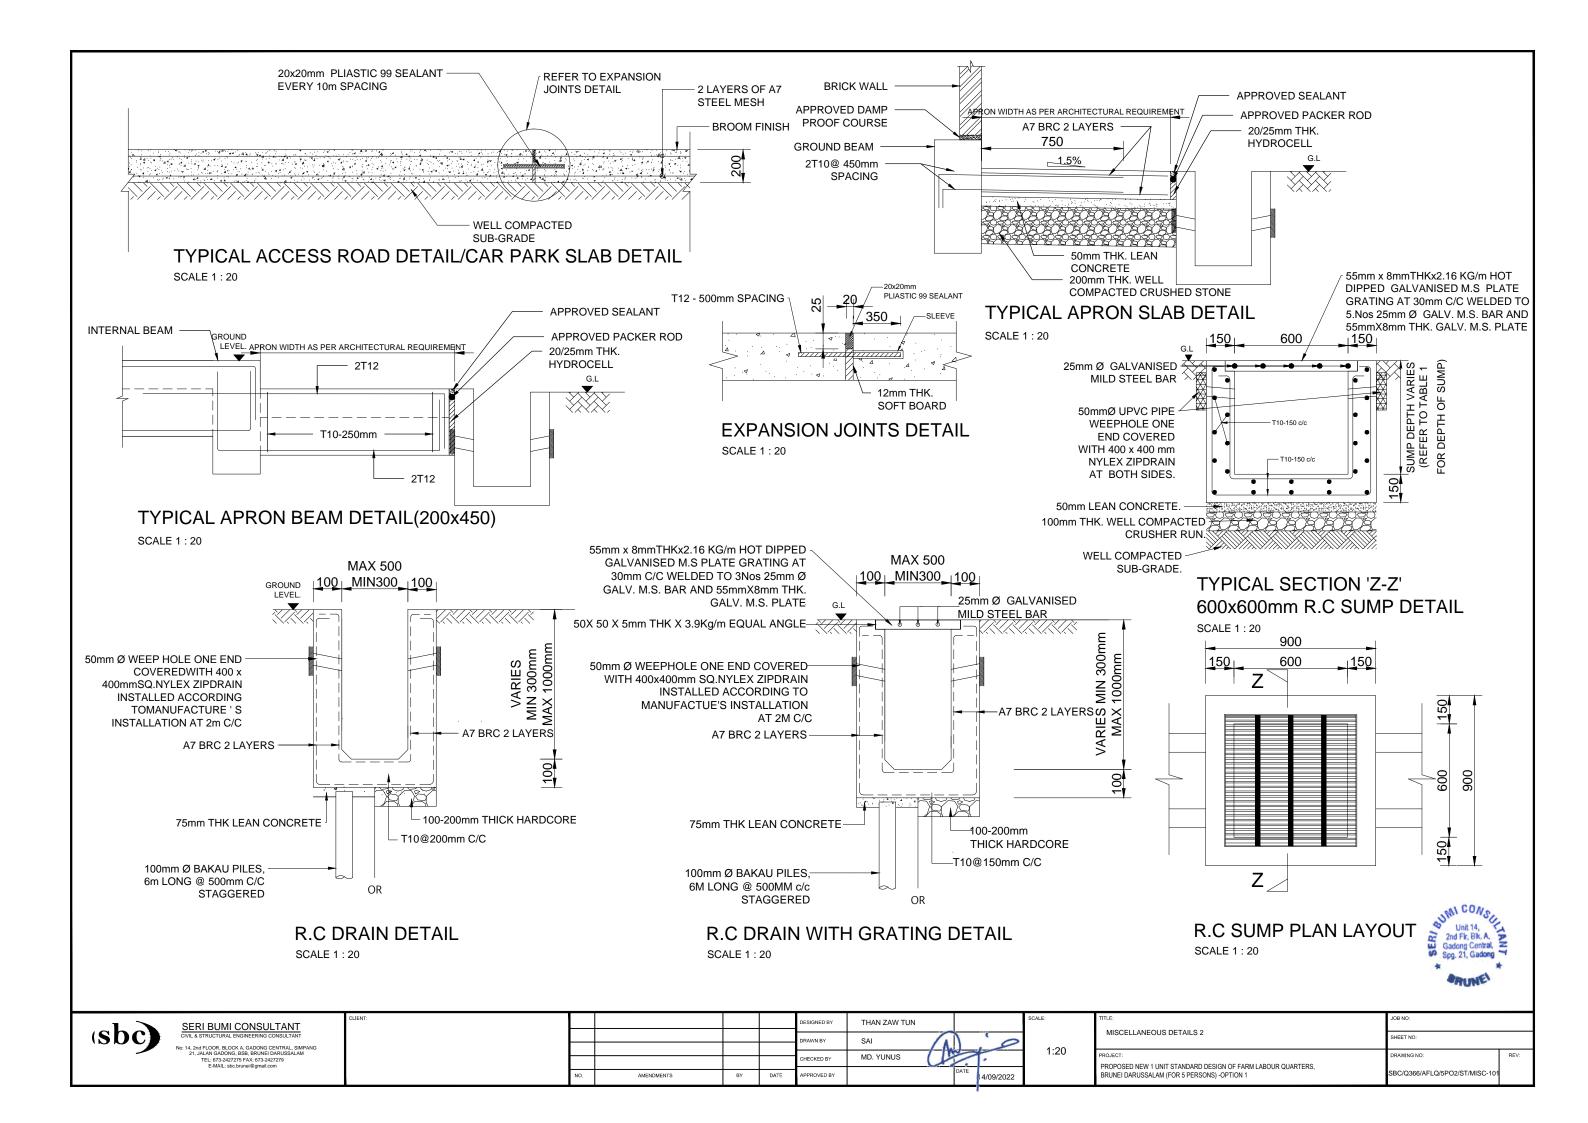

# ABANK\SharedFolder\JOMC Projects\254 - Design Services for Agricultral Farm Labour Quarters (M&E)\1. Dravings\2. workshop dravings\22096\REVI\ JOMC-254-5 PERSONS OPT2-M&

# PROPOSED NEW 1 UNIT STANDARD DESIGN OF FARM LABOUR QUARTERS, BRUNEI DARUSSALAM (FOR 5 PERSONS) - OPTION 2

# **DRAWING LIST**

ITEM	DRAWING NUMBER	DRAWING TITLE
1	JOMC/254/FH/100	SITE DEVELOPMENT PLAN FIRE HYDRANT LAYOUT PLAN - (FOR 5 PERSONS OPTION 2)
2	JOMC/254/AC/200	GROUND FLOOR AIR CONDITIONING LAYOUT - (FOR 5 PERSONS OPTION 2)
3	JOMC/254/L/200	GROUND FLOOR LIGHTING LAYOUT - (FOR 5 PERSONS OPTION 2)
4	JOMC/254/P/200	GROUND FLOOR POWER LAYOUT - (FOR 5 PERSONS OPTION 2)
5	JOMC/254/P/300	SOLAR SYSTEM LAYOUT DIAGRAM - (FOR 5 PERSONS OPTION 2)
6	JOMC/254/F/200	GROUND FLOOR FIRE PROTECTION LAYOUT - (FOR 5 PERSONS OPTION 2)
7	JOMC/254/T/200	GROUND FLOOR TELEPHONE LAYOUT - (FOR 5 PERSONS OPTION 2)
8	JOMC/254/T/300	TELEPHONE SYSTEM SCHEMATIC DIAGRAM - (FOR 5 PERSONS OPTION 2)
9	JOMC/254/W/200	GROUND FLOOR PLUMBING LAYOUT - (FOR 5 PERSONS OPTION 2)
10	JOMC/254/W/300	PLUMBING SCHEMATIC DIAGRAM - (FOR 5 PERSONS OPTION 2)
11	JOMC/254/SEW/200	GROUND FLOOR SANITARY LAYOUT - (FOR 5 PERSONS OPTION 2)
12	JOMC/254/SEW/300	SANITARY SCHEMATIC DIAGRAM - (FOR 5 PERSONS OPTION 2)
13	JOMC/254/SEW/301	SANITARY SEWER LINE INVERT LEVEL - (FOR 5 PERSONS OPTION 2)


Copyright.©					CLIENT
"This document is and shall remain the property of JOMC. The document may only be used for the purpose for which it was commisioned and in					DEPARTMENT OF AGRICULTURE AND
accordance with the terms of engagement for the commision. Unauthorised use of the document in					AGRIFOOD, BRUNEI DARUSSALAM
any way is prohibited."					
GENERAL NOTES	REV	DESCRIPTION	DATE	BY	





PROJECT TITLE  PROPOSED NEW 1 UNIT STANDARD DESIGN	DRAWING
OF FARM LABOUR QUARTERS, BRUNEI DARUSSALAM (FOR 5 PERSONS) - OPTION 2	DRAWN BY
DARGOGALAM (FOR OT ERCORO) - OT TION 2	CHECKED
	DRAWING I

DRAWING TITLE						
DRAWING LIST - SHEET 1 OF 1 - (FOR 5 PERSONS OPTION 2)						
DRAWN BY:	FS	DESIGN BY:	FS	SCALE:	NTS	
CHECKED BY:	CLT	DATE:	SEPT 2022	JOB NO:	254	
DRAWING NO:		IOMO	1254/DWG/0	100	·	

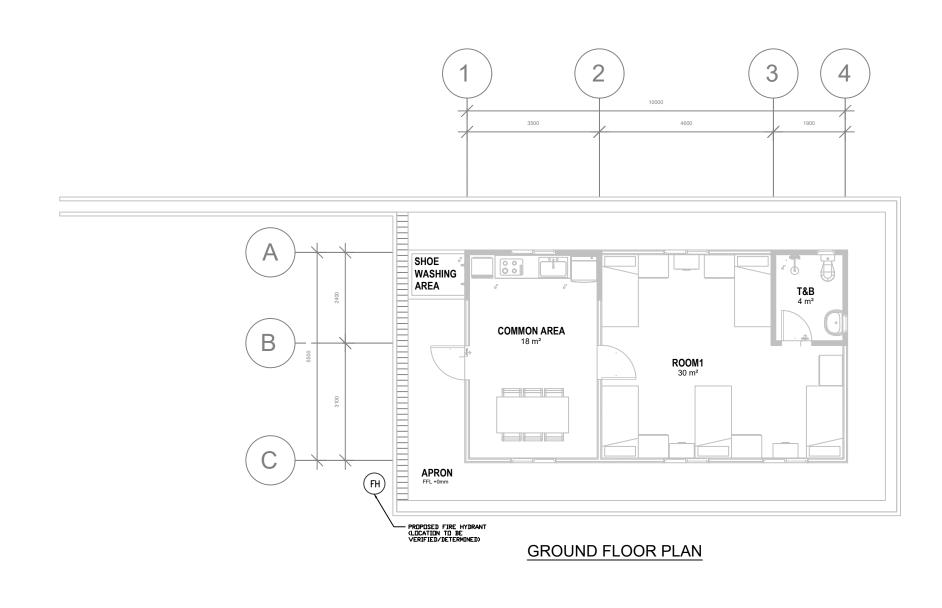

Copyright. ©
"This document is and shall remain the property of JOMC. The document may only be used for the purpose for which it was commisioned and in accordance with the terms of engagement for the commision. Unauthorised use of the document in any way is prohibited." GENERAL NOTES DESCRIPTION

DEPARTMENT OF AGRICULTURE AND AGRIFOOD, BRUNEI DARUSSALAM

DATE BY








PROPOSED NEW 1 UNIT STANDARD DESIGN OF FARM LABOUR QUARTERS, BRUNEI DARUSSALAM (FOR 5 PERSONS) - OPTION 2

AWING TITLE	
SITE DEVELOPMENT PLAN FIRE	
- (FOR 5 PERSONS	OPTI

	District inter	=						
3N	SITE		MENT PLAN (FOR 5 PERS		ANT LAYOU ON 2)	T PLAN		
12	DRAWN BY:	FS	DESIGN BY:	FS	SCALE:	1:100		
_	CHECKED BY:	CLT	DATE:	SEPT 2022	JOB NO:	254		
	DRAWING NO:		JOMC/254/FH/100					

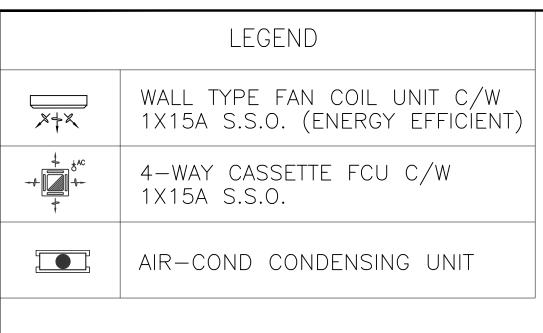

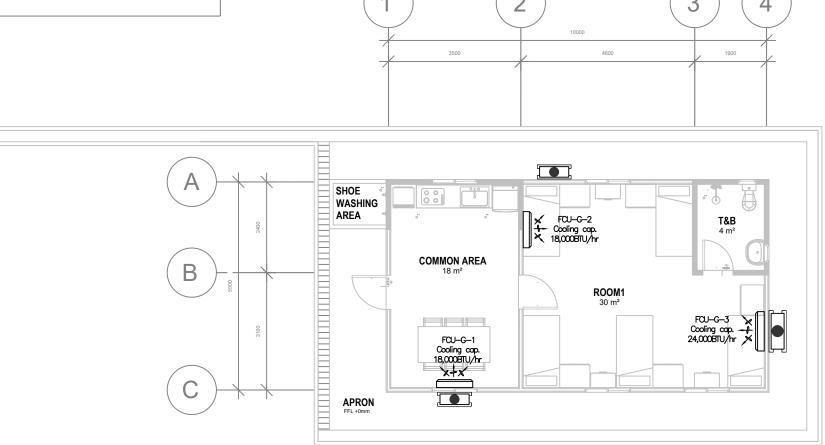

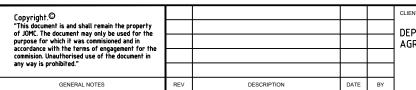

DEPARTMENT OF AGRICULTURE AND AGRIFOOD, BRUNEI DARUSSALAM





PROJECT TITLE


PROPOSED NEW 1 UNIT STANDARD DESIGN
OF FARM LABOUR QUARTERS, BRUNEI
DARUSSALAM (FOR 5 PERSONS) - OPTION 2


DRAWING TITLE					
G	GROUND FLOOR PLAN AIR-CONDITIONING LAYOUT - (FOR 5 PERSONS OPTION 2)				
DRAWN BY:	FS	DESIGN BY:	FS	SCALE:	1:100

 DRAWN BY:
 FS
 DESIGN BY:
 FS
 SCALE:
 1:100

 CHECKED BY:
 CLT
 DATE:
 SEPT 2022
 JOB NO:
 254

 DRAWING NO:
 JOMC/254/AC/200

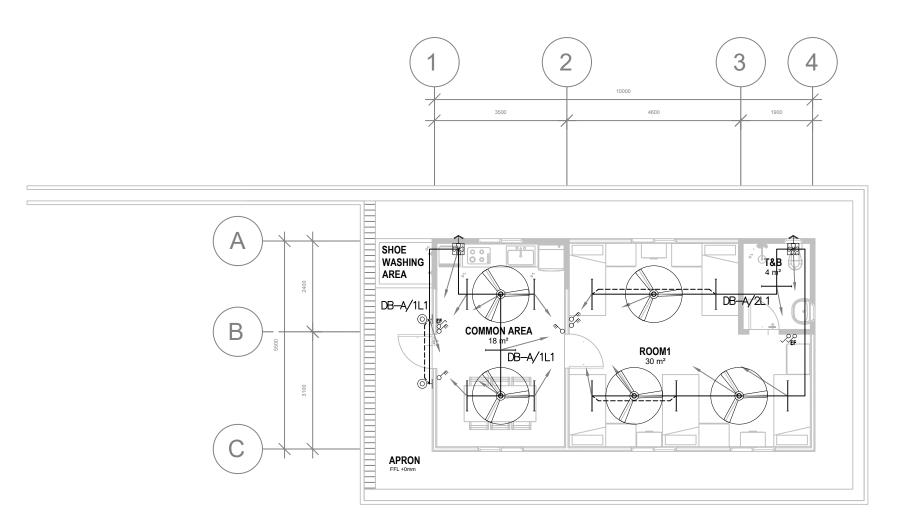

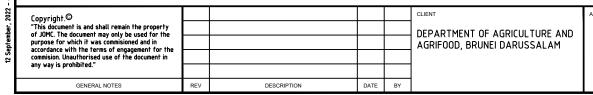






ROJECT TITLE

	PROPOSED NEW 1 UNIT STANDARD DESIGN	
ı	OF FARM LABOUR QUARTERS, BRUNEI DARUSSALAM (FOR 5 PERSONS) - OPTION 2	DRA
ı	DARUSSALAM (FOR 5 PERSONS) - OPTION 2	5.0
ı		0115

DRAWING TITLE	GROUN	D FLOOR PL (FOR 5 PERS			
DRAWN BY:	FS	DESIGN BY:	FS	SCALE:	1:100
CHECKED BY:	CLT	DATE:	SEPT 2022	JOB NO:	254

JOMC/254/L/200

	LEGEND	Ī
SYMBOL	DESCRIPTION	
ţ	1X13A SWITCH SOCKET OUTLET TO DES / DME APPROVED TYPE	
<del>*************************************</del>	2X13A SWITCH SOCKET OUTLET TO DES / DME APPROVED TYPE	1
→wP	1X13A WEATHERPROOF SWITCH SOCKET OUTLET TO DES / DME APPROVED TYPE	]
Jac	1X15A S.S.O FOR AC INSTALLED ON THE HIGH LEVEL TO DES / DME APPROVED TYPE	
	ELECTRICAL DISTRIBUTION BOARD TO DES / DME APPROVED TYPE	
Ć	COOKER UNIT C/W 1x13A SSO TO DES / DME APPROVED TYPE	
3	WATER HEATER ® 5 GALLONS CAPACITY C/W 20A DOUBLE POLE NEON SWITCH	
M	PREPAID METER TO DES / DME APPROVED TYPE	

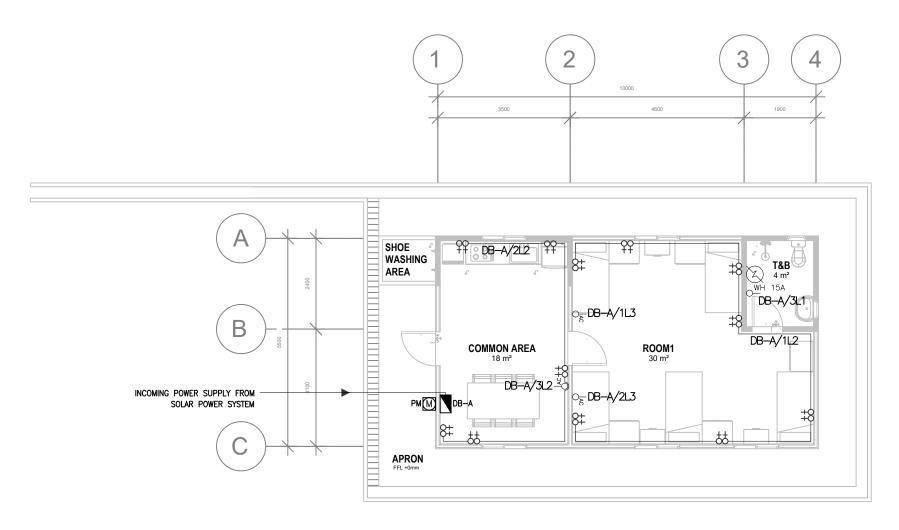

Copyright.   "This document is and shall remain the property of JOMC. The document may only be used for the purpose for which it was commisioned and in accordance with the terms of engagement for the commision. Unauthorised use of the document in					CLIENT
					DEPARTMENT OF AGRICULTURE AND
					AGRIFOOD, BRUNEI DARUSSALAM
any way is prohibited."					
GENERAL NOTES	REV	DESCRIPTION	DATE	BY	






PROJECT TITLE

PROPOSED NEW 1 UNIT STANDARD DESIGN
OF FARM LABOUR QUARTERS, BRUNEI
DARUSSALAM (FOR 5 PERSONS) - OPTION 2

DRAWING TITLE  GROUND FLOOR PLAN POWER LAYOUT							
		FOR 5 PERS					
DRAWN BY:	FS	DESIGN BY:	FS	SCALE:			

12	DRAWN BY:	FS	DESIGN BY:	FS	SCALE:	1:100
_	CHECKED BY:	CLT	DATE:	SEPT 2022	JOB NO:	254
	DRAWING NO:		JON	1C/254/P/200	)	

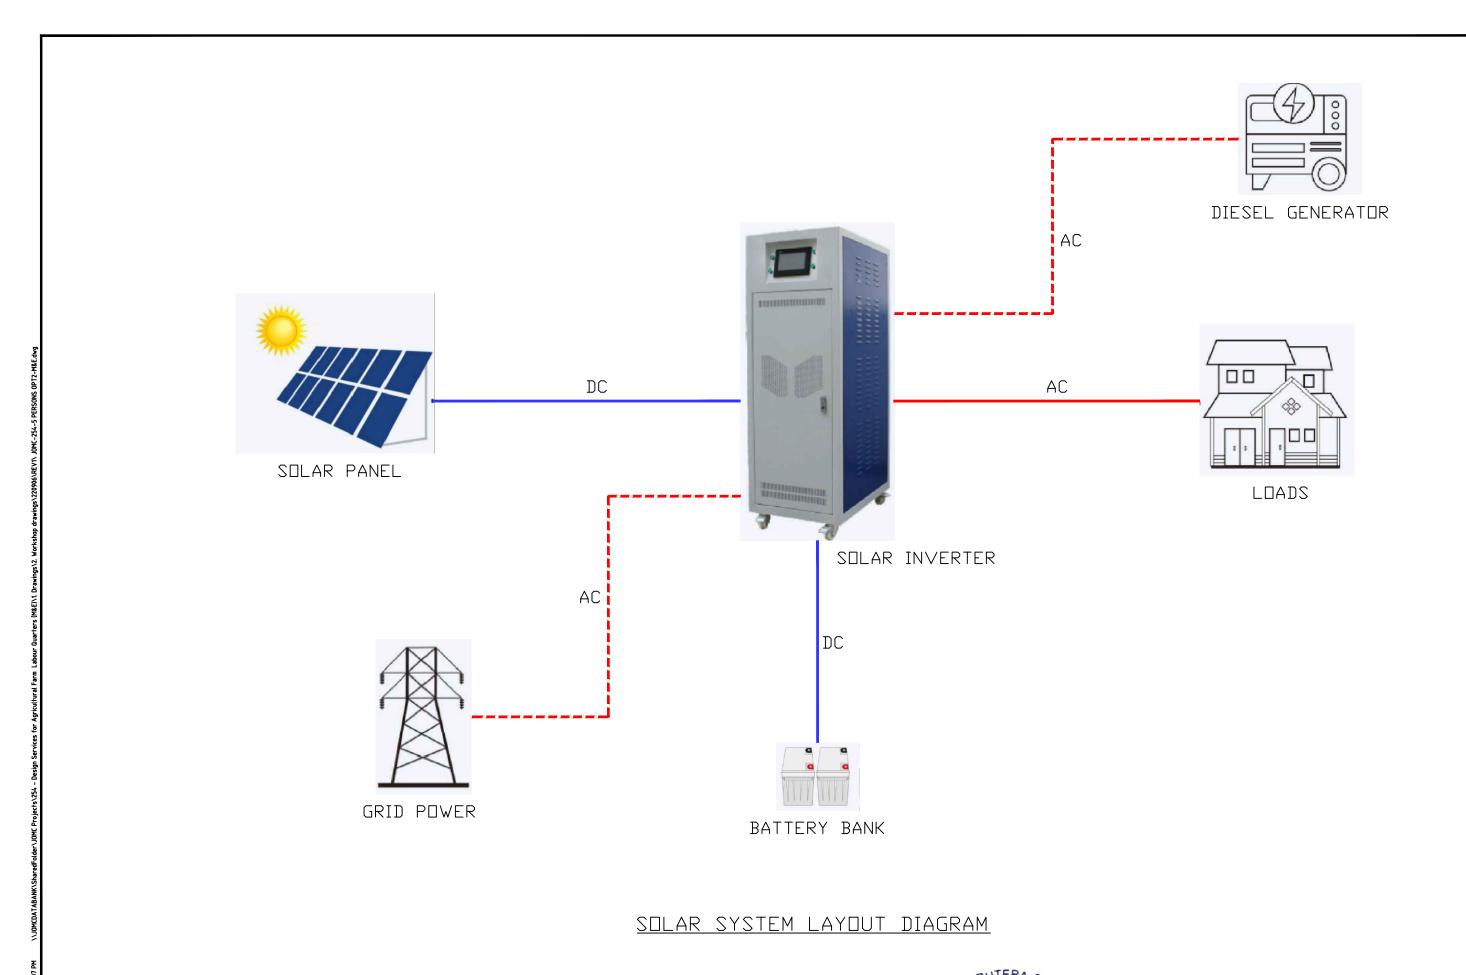

Copyright.©

"This document is and shall remain the property of JOMC. The document may only be used for the purpose for which if was commissioned and in accordance with the terms of engagement for the commission. Unauthorised use of the document in any way is prohibited."

GENERAL NOTES

REV

DESCRIPTION

DATE

BY

CLIENT

DEPARTMENT OF AGRICULTURE AND AGRIFOOD, BRUNEI DARUSSALAM






PROPOSED NEW 1 UNIT STANDARD DESIGN	
OF FARM LABOUR QUARTERS, BRUNEI DARUSSALAM (FOR 5 PERSONS) - OPTION 2	DI
DARGOGALAM (FOR OT ERCORO) - OF FIGH 2	C

PROJECT TITLE

DRAWING TITLE									
SOLAR SYSTEM LAYOUT DIAGRAM - (FOR 5 PERSONS OPTION 2)									
DRAWN BY:	FS	DESIGN BY:	FS	SCALE:	NTS				
CHECKED BY:	CHECKED BY: CLT DATE: SEPT 2022 JOB NO: 254								
DRAWING NO:	JOMC/254/P/300								

SYMBOL	DESCRIPTION
FB	FIRE BLANKET TO BOMBA APPROVED TYPE
E	10W EMERGENCY LIGHTING TO BOMBA APPROVED TYPE
S	SMOKE DETECTOR TO BOMBA APPROVED TYPE
<u> </u>	4.5kg ABC DRY POWDER FIRE EXTINGUISHER TO BOMBA APPROVED TYPE
$\triangle$	2.3kg CO2 FIRE EXTINGUISHER TO BOMBA APPROVED TYPE
MFAP	FIRE ALARM PANEL TO BOMBA APPROVED TYPE

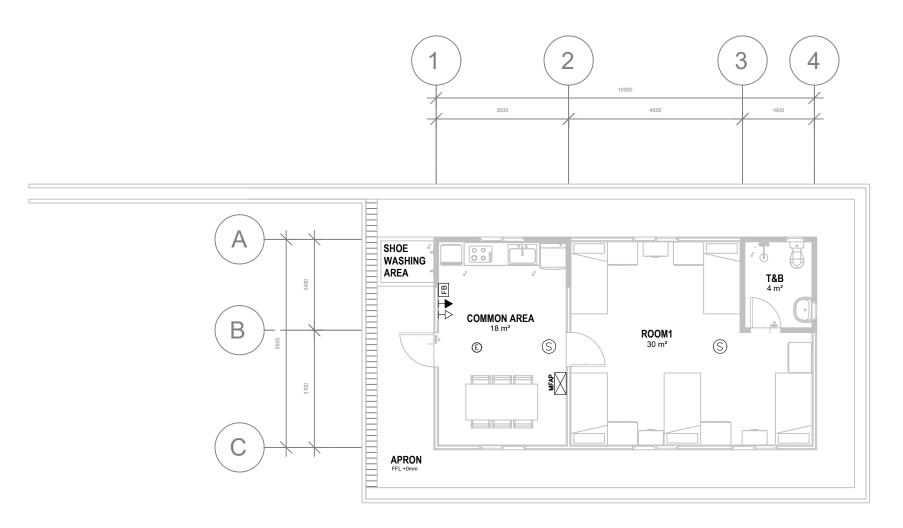








PROJECT TITLE

PROPOSED NEW 1 UNIT STANDARD DESIGN OF FARM LABOUR QUARTERS, BRUNEI DARUSSALAM (FOR 5 PERSONS) - OPTION 2

DRAWING TITLE									
G	GROUND FLOOR PLAN FIRE PROTECTION LAYOUT - (FOR 5 PERSONS OPTION 2)								
	50		F0.		4.400				

2	DRAWN BY:	FS	DESIGN BY:	FS	SCALE:	1:100
-	CHECKED BY:	CLT	DATE:	SEPT 2022	JOB NO:	254
	DRAWING NO:		JON	/IC/254/F/200	)	

SYMBOL	DESCRIPTION
<b>₽</b>	TELEPHONE OUTLET POINT (WITH INTERCOM) TO BE INSTALLED AT 350mm HEIGHT TO UNN APPROVED TYPE
FJB	FOOT JUNCTION BOX (FJB) TO UNN APPROVED TYPE
	FIBER DISTRIBUTION TERMINAL (FDT) TO UNN APPROVED TYPE
	ACCESS TERMINATION BOX TO UNN APPROVED TYPE
AP	ACCESS POINT TO UNN APPROVED TYPE

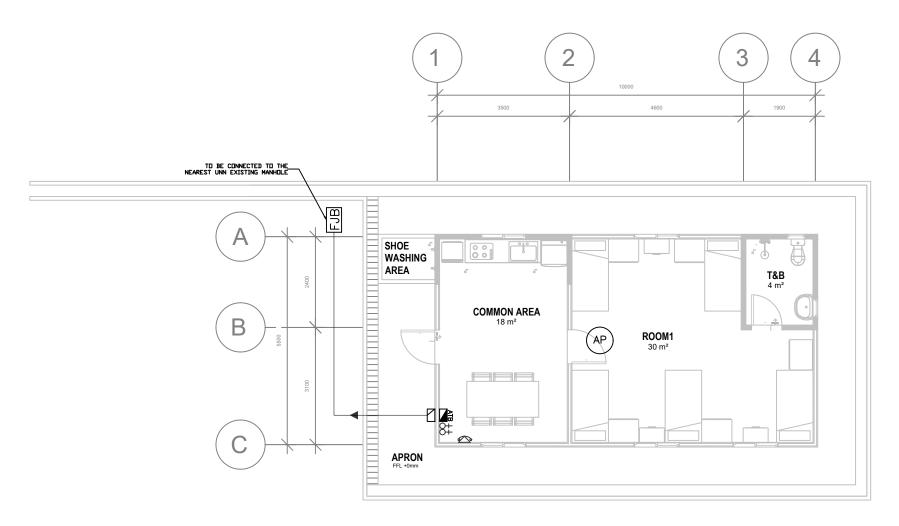

Copyright.©					CLIENT
"This document is and shall remain the property of JOMC. The document may only be used for the					DEPARTMENT OF AGRICULTURE AND
purpose for which it was commisioned and in accordance with the terms of engagement for the	nmisioned and in				AGRIFOOD, BRUNEI DARUSSALAM
commision. Unauthorised use of the document in					•
any way is prohibited."					
CENERAL NOTES	DEV/	DESCRIPTION	DATE	DV.	






PROJECT TITLE

PROPOSED NEW 1 UNIT STANDARD DESIGN
OF FARM LABOUR QUARTERS, BRUNEI
DARUSSALAM (FOR 5 PERSONS) - OPTION 2

DRAWING TITLE	≣				
		ND FLOOR PL - (FOR 5 PER			Т
DRAWN BY:	FS	DESIGN BY:	FS	SCALE:	1:100
CHECKED BY:	CLT	DATE:	SEPT 2022	JOB NO:	254

JOMC/254/T/200

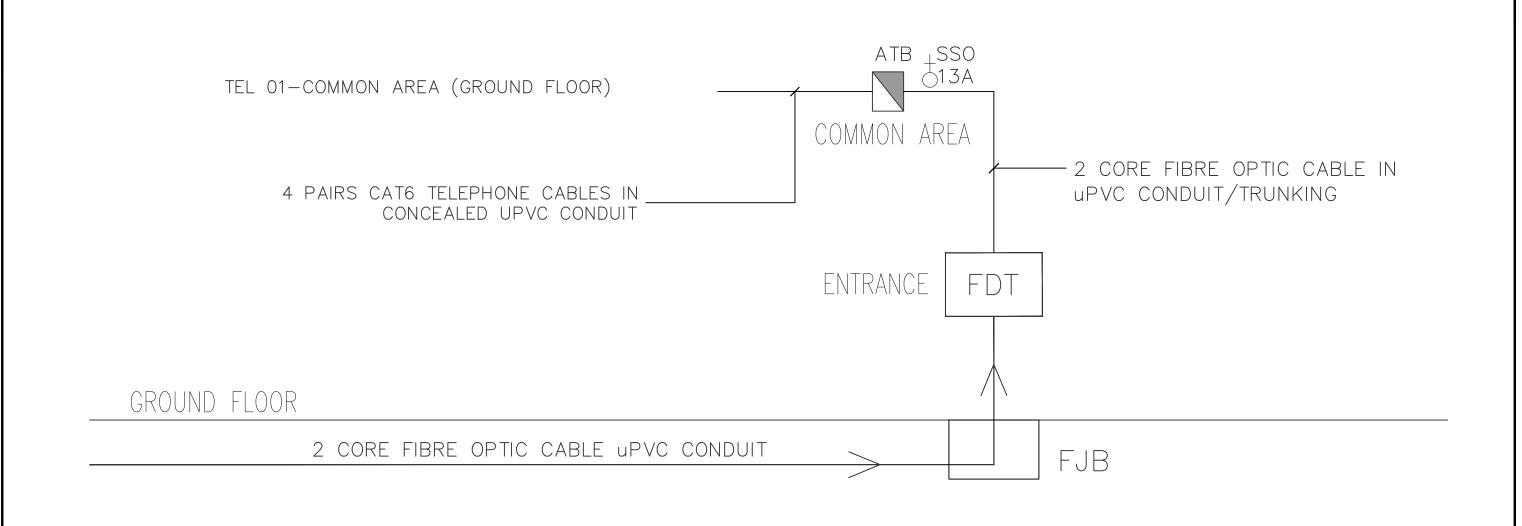

# TELEPHONE SYSTEM SCHEMATIC DIAGRAM

Copyright. ©

"This document is and shall remain the property of JOMC. The document may only be used for the purpose for which it was commissioned and in accordance with the terms of engagement for the commission. Unauthorised use of the document in any way is prohibited."

GENERAL NOTES

REV

DESCRIPTION

DATE

BY

CLIENT

DEPARTMENT OF AGRICULTURE AND AGRIFOOD, BRUNEI DARUSSALAM





PROPOSED NEW 1 UNIT STANDARD DESIGN
OF FARM LABOUR QUARTERS, BRUNEI
DARUSSALAM (FOR 5 PERSONS) - OPTION 2

 DRAWING TITLE


 TELEPHONE SYSTEM SCHEMATIC DIAGRAM - (FOR 5 PERSONS OPTION 2)

 DRAWN BY:
 FS
 DESIGN BY:
 FS
 SCALE:
 NTS

 CHECKED BY:
 CLT
 DATE:
 SSPT.2022
 JOB NO:
 254

 DRAWING NO:
 JOMC/254/T/300

LEGEND	
$\bowtie$	Gate Valve
KS	Kitchen Sink
WC	Water Closet
WT	Water Tap
WB	Water Basin
	Cold Water
	Hot Water
<b>\</b>	

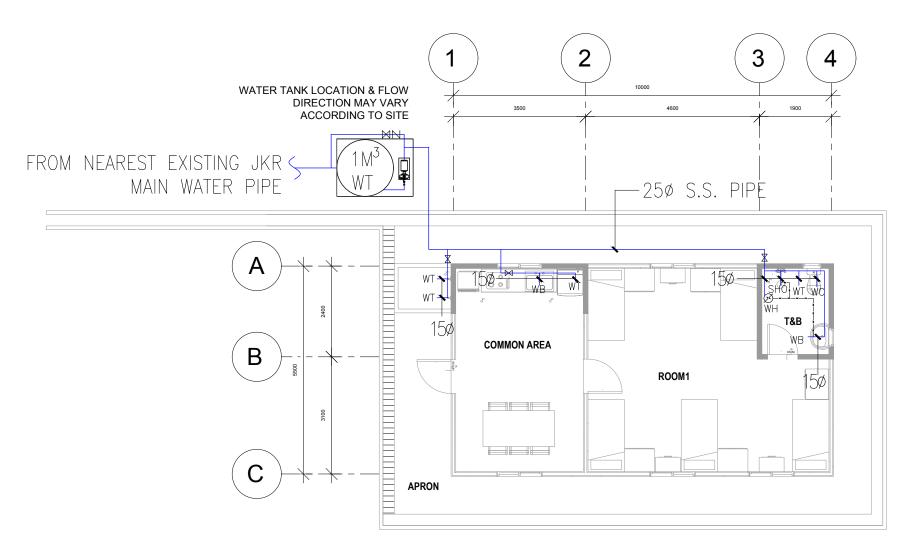







PROPOSED NEW 1 UNIT STANDARD DESIGN OF FARM LABOUR QUARTERS, BRUNEI DARUSSALAM (FOR 5 PERSONS) - OPTION 2

PROJECT TITLE

GROUND FLOOR PLAN PLUMBING LAYOUT (FOR 5 PERSONS OPTION 2)							
DRAWN BY:	AIM	DESIGN BY:	AIM	SCALE:	1:100		
CHECKED BY: CLT DATE: SEPT 2022 JOB NO: 254							
DRAWING NO:	JOMC/254/W/200						

# NOTES:

# HOT WATER PIPEWORK

- 1. ALL HOT WATER PIPEWORK TO BE COPPER TO BS 2871 : 1971 M TABLE X. JOINTS COMPRESSION FITTING TO BS 864 : PART 2 : 1983 TYPE A.
- 2. HOT WATER PIPEWORK EMBEDDED IN WALL SHALL BE DENSO OR POLYETHLENE WRAPPED.
- 3. HOT WATER PIPEWORK NOT EMBEDDED IN WALL TO BE INSULATED WITH 25MM PREFORMED FIBRE GLASS INSULATION WITH FACTORY APPLIED ALUMINIUM JACKET SEAL JOINTS WITH PRESSURE SENSITIVE TAPE.

# COLD WATER PIPEWORK


- 1. ALL COLD WATER PIPEWORK ABOVE GROUND TO BE:
- i) BELOW 80 MM

PIPEWORK TO BE STAINLESS STEEL TO BS 4127.
JOINTS COMPRESSION & FITTINGS TO
BS 864: PART 2.

- 2. ALL COLD WATER PIPEWORK BURIED UNDERGROUND TO BE:
- i) 80 MM AND BELOW
  STAINLESS STEEL PIPE TO BS 41271.
  JOINTS COMPRESSION & FITTINGS TO
  BS 864: PART 2.
- ii) 80 MM AND ABOVE

MDPE PIPE TO BS 6920 : 1988 : PART 2. JOINTS COMPRESSION & FITTINGS TO DIN 16928 : PART 1 TO 12

- 3. ALL FINAL CONNECTION TO BE 150 UNLESS OTHERWISE STATED
- 4. PROVIDE A STOP COCK FOR WATER INLET TO EVERY PLUMBING & SANITARY FIXTURES.
- 5. ALL STOP COCKS TO BE CHROME PLATED TYPE.
- 6. ALL PIPES ARE IN MM.
- 7. WATER PIPE 65 MM AND BELOW USED FOR CONNECTION BETWEEN THE WATER MAIN TAP-OFF AND THE WATER METER SHALL BE STAINLESS STEELS PIPE TO BS4127:PART 2.

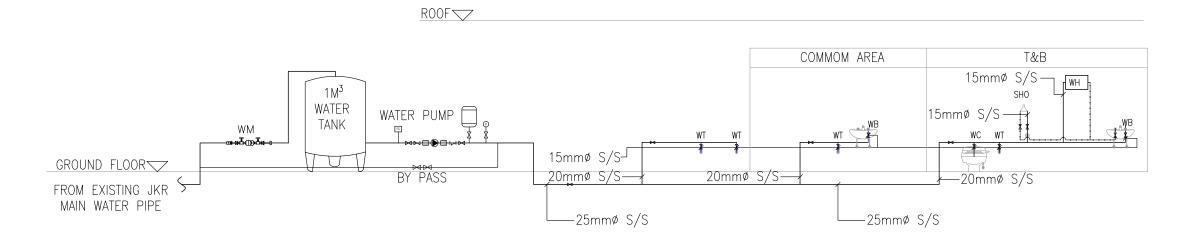

prember, 2022 - 11:55 AM C:\Users\user\Deskrop\MIRUL\254 - agricultural Tarm la

Copyright.©
"This document is and shall remain the property of JOMC. The document may only be used for the purpose for which it was commissioned and in accordance with the terms of engagement for the commission. Unauthorised use of the document in any way is prohibited."

GENERAL NOTES REV DESCRIPTION DATE BY

KHA AND PLOI BRIDGE OF A FINANCIA PLOI BRIDG



DODOSED NEW 4 LINIT STAN

PROPOSED NEW 1 UNIT STANDARD DESIGN OF FARM LABOUR QUARTERS, BRUNEI DARUSSALAM (FOR 5 PERSONS) - OPTION 2

DRAWING TITLE			IMBING TIC DIAGRA SONS OPTIC				
DRAWN BY:	AM DESIGN BY: AM SCALE: NT						
CHECKED BY:	CLT	DATE:	SEPT 2022	JOB NO:	254		
DRAWING NO:	IOMC/254/M/300						

LEGEND

DESCRIPTION

150MMØ VC PIPE

MANHOLE TYPE A

(CAPACITY 8 PERSONS)

80MMØ WASTE PIPE

100MMØ SOIL PIPE

100MMØ VENT PIPE

GULLY TRAP


SEPTIC TANK

Copyright. © "This document is and shall remain the property of JOMC. The document may only be used for the purpose for which if was commisioned and in accordance with the terms of engagement for the commission. Unauthorised use of the document in					CLIENT
					DEP A
					AGRI
any way is prohibited."					
GENERAL NOTES	RFV	DESCRIPTION	DATE	BY	








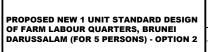


GROUND FLOOR PLAN SANITARY LAYOUT (FOR 5 PERSONS OPTION 2) RAWN BY: RAWING NO: JOMC/254/SEW/200

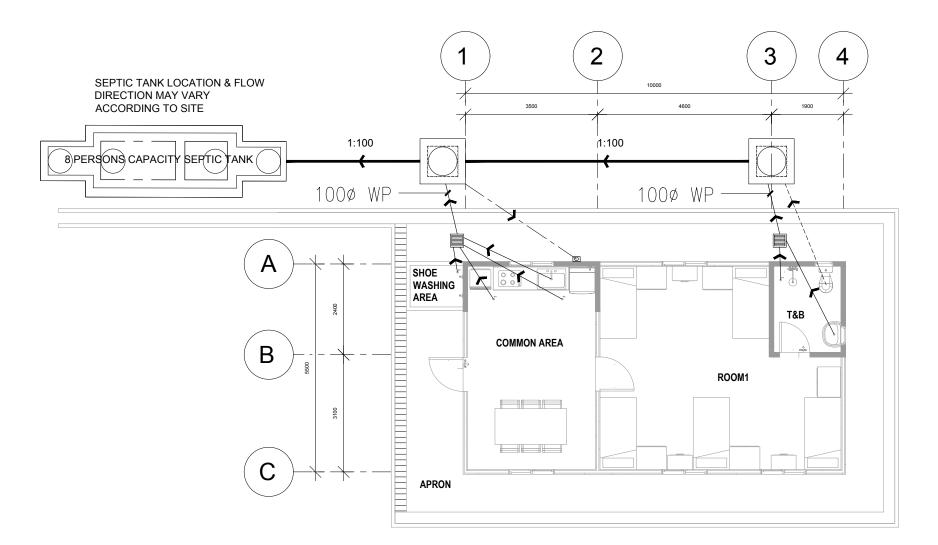

GROUND FLOOR PLAN



GENERAL NOTES

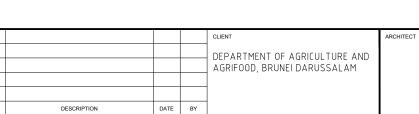






PROPOSED NEW 1 UNIT STANDARD DESIGN OF FARM LABOUR QUARTERS, BRUNEI DARUSSALAM (FOR 5 PERSONS) - OPTION 2

PROJECT TITLE

SANITARY SCHEMATIC DIAGRAM (FOR 5 PERSONS OPTION 2) DRAWING TITLE DESIGN BY: AIM SCALE: RAWN BY: SEPT 2022 JOB NO: HECKED BY: RAWING NO: JOMC/254/SEW/300

R00F ▽		450MM —	COPPER WIRE MESH CAGE ON TOP OF THE UPVC COWL
		v	100mmø uPVC Vent Pipe
	GROUNE	) FLOOR	
	T&B	COMMON AREA	
GF	32¢ WB 50¢ WC 80¢ T GT1	100ø FT 40ø	SEPTIC TANK CAPACITY 8 PERSON  1000  1500 VC PIPE

NOTE: CONTRACTOR TO DETERMINE THE FINAL DATUM LEVEL AT SITE.

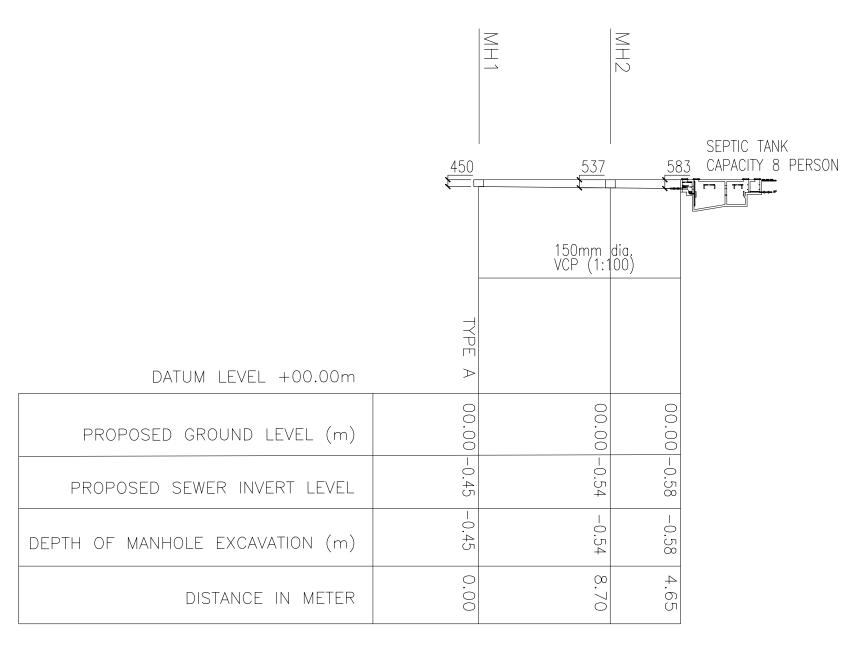

of JOMC. The document may only be u purpose for which it was commisioned accordance with the terms of engage commision. Unauthorised use of the d	Copyright.©					CLIENT
	"This document is and shall remain the property of JOMC. The document may only be used for the					DEP
	purpose for which it was commisioned and in accordance with the terms of engagement for the					AGR
	commision. Unauthorised use of the document in any way is prohibited."					
any way is promotied.	any way is prombined.					
	GENERAL NOTES	REV	DESCRIPTION	DATE	BY	

EPARTMENT OF AGRICULTURE AND GRIFOOD, BRUNEI DARUSSALAM





PROPOSED NEW 1 UNIT STANDARD DESIGN OF FARM LABOUR QUARTERS, BRUNEI DARUSSALAM (FOR 5 PERSONS) - OPTION 2

DRAWING TITLE SANITARY SEWER LINE INVERT LEVEL (FOR 5 PERSONS OPTION 2)									
DRAWN BY:	AIM	DESIGN BY:	AIM	SCALE:	NTS				
CHECKED BY:	CLT	DATE:	SEPT 2022	JOB NO:	254				
DRAWING NO:	JOMC/254/SFW/301								